STATE OF HAWAII

DEPARTMENT OF LAND AND NATURAL RESOURCES

ENGINEERING DIVISION

DIVISION OF STATE PARKS

JOB NO. F27C793A

HEEIA STATE PARK, IMPROVEMENTS TO BANQUET HALL BUILDING

KANEOHE, OAHU, HAWAII 96744

TMK: 4-6-005: 009

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DESCRIPTION

APPROVED:

DATE: MAK 9°H 266

CURT A. COTTRELL
ADMINISTRATOR
DIVISION OF STATE PARKS
DEPARTMENT OF LAND AND NATURAL RESOURCES

APPROVED:

DATE: 5/13/16

CARTY S. CHANG, P.E.
CHIEF ENGINEER
ENGINEERING DIVISION
DEPARTMENT OF LAND AND NATURAL RESOURCES

MAP OF OAHU NOT TO SCALE

PROJECT LOCATION


HEEIA STATE PARK IMPROVEMENTS TO BANQUET HALL BUILDING


DIAMOND HEAD


LOCATION MAP


Carty Chang E-signed 2016-08-17 03:03PM HST carty.s.chang@hawaii.gov


DRAWING NO.

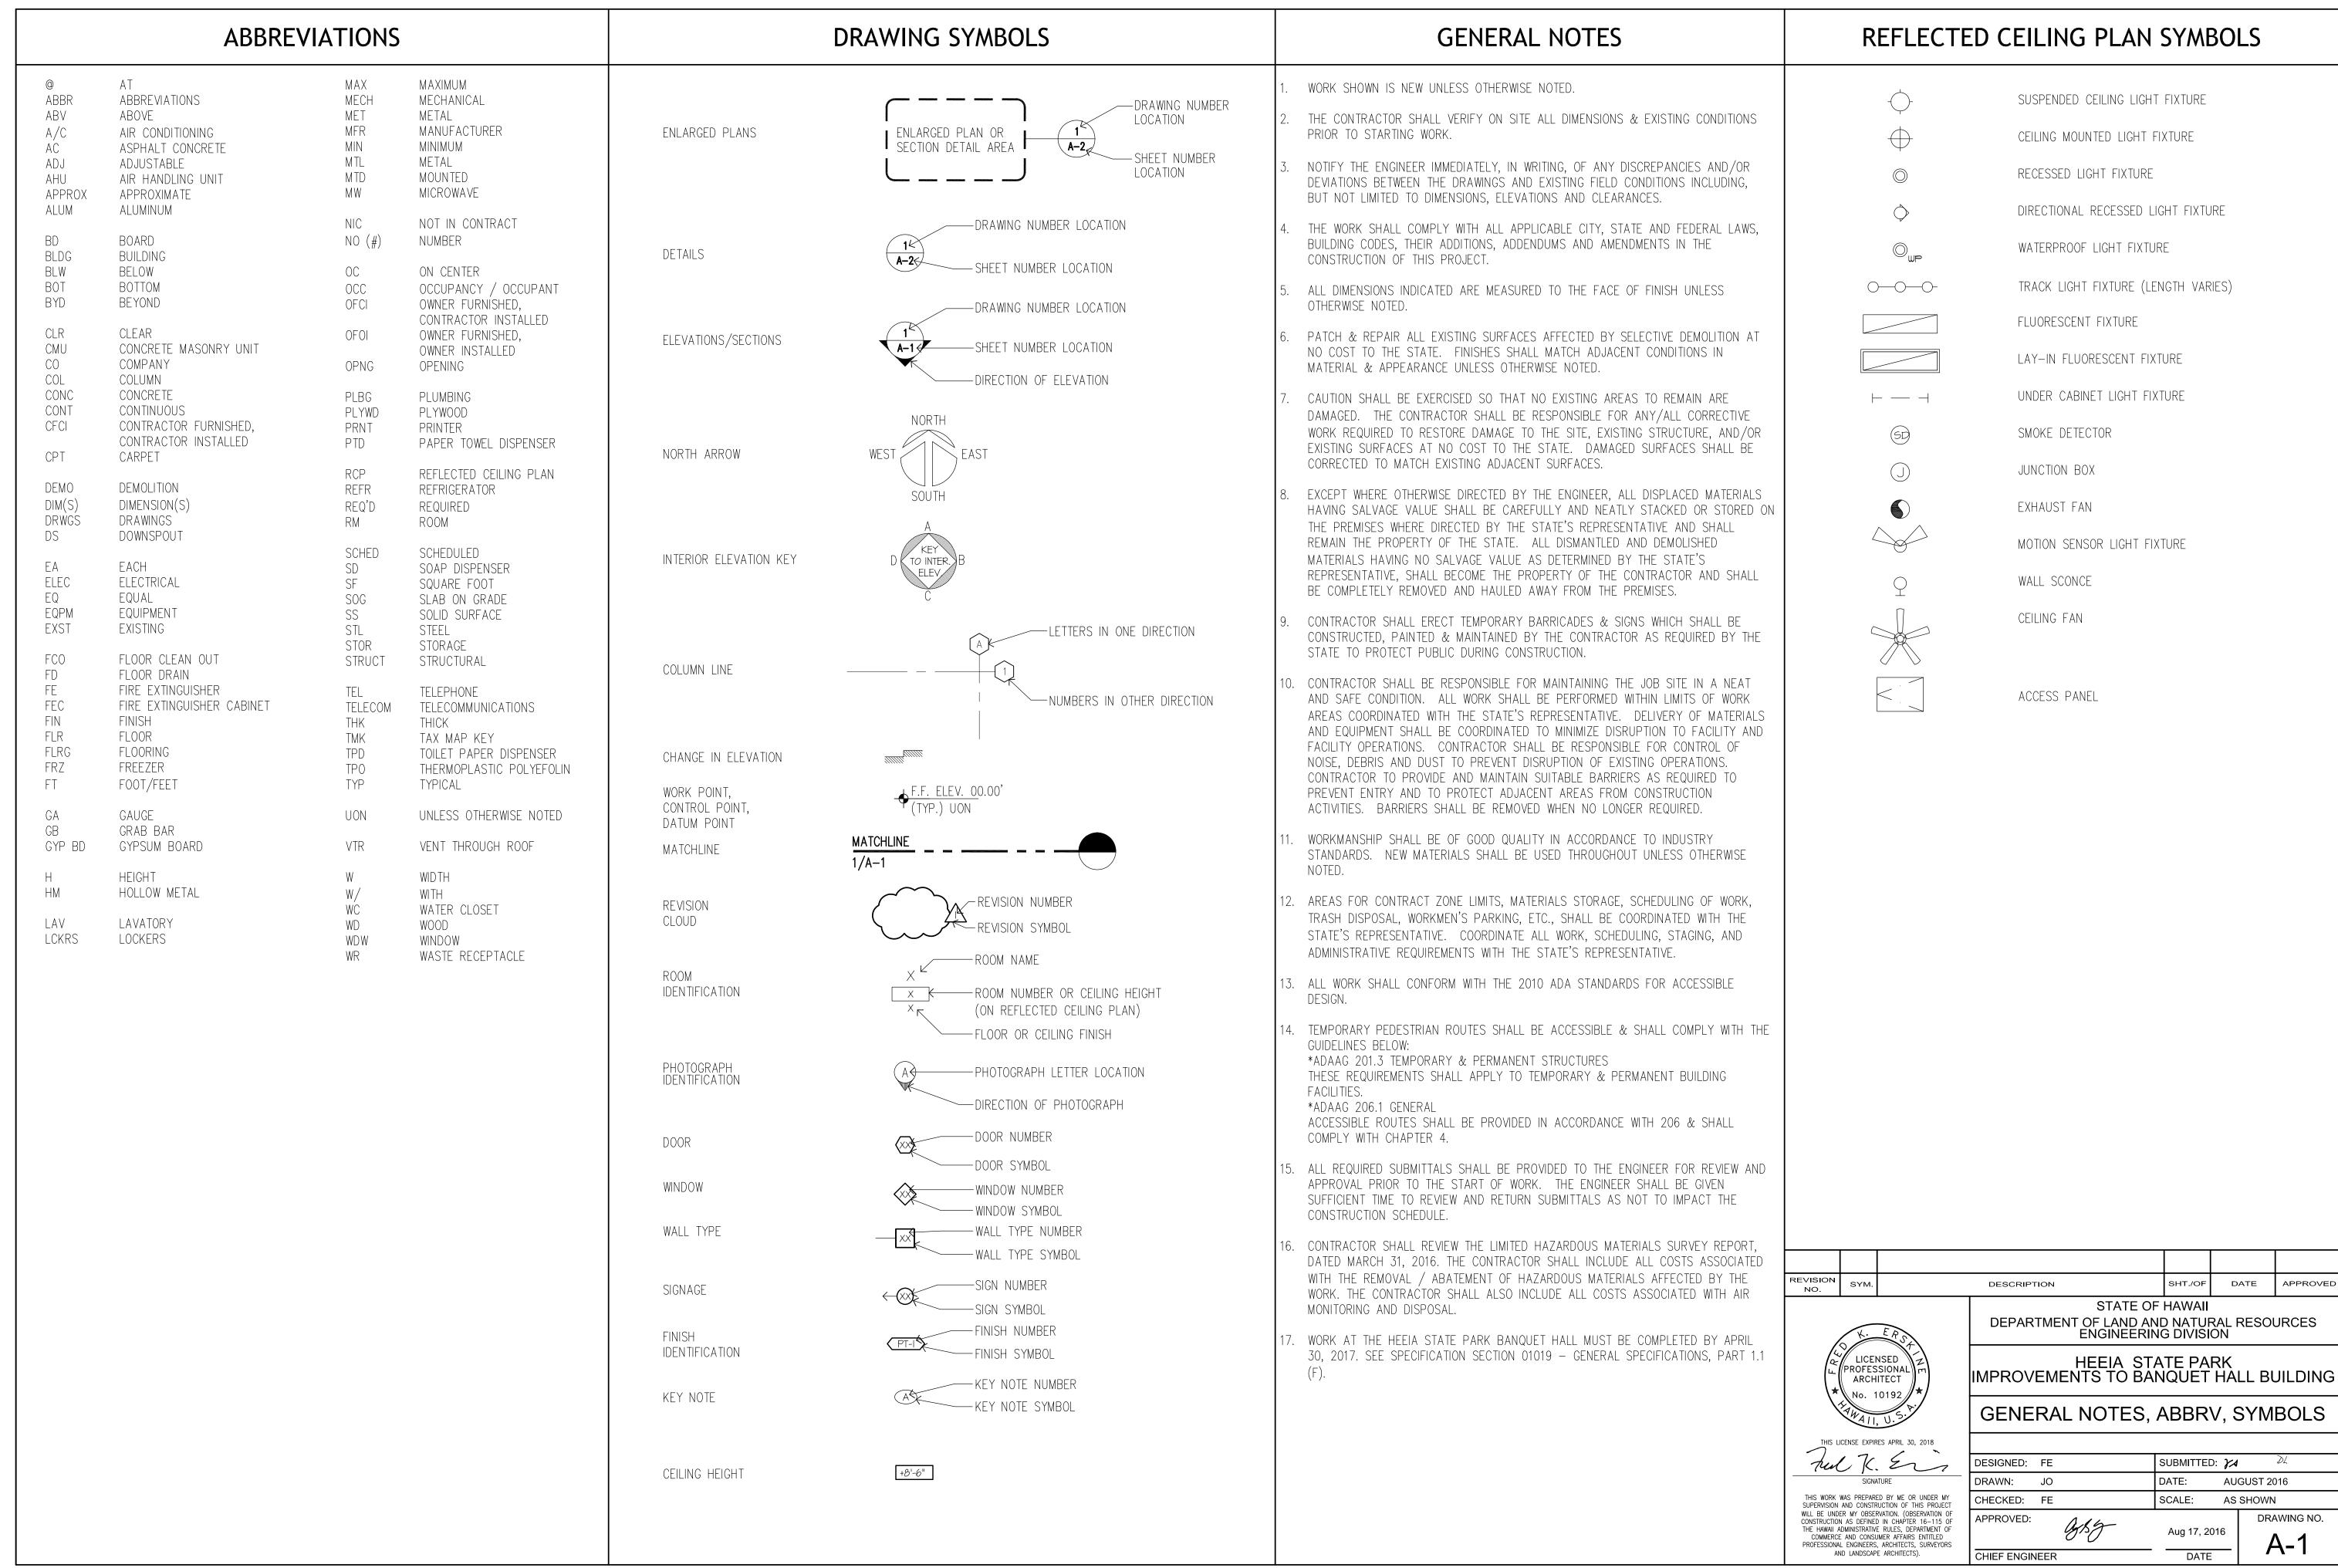

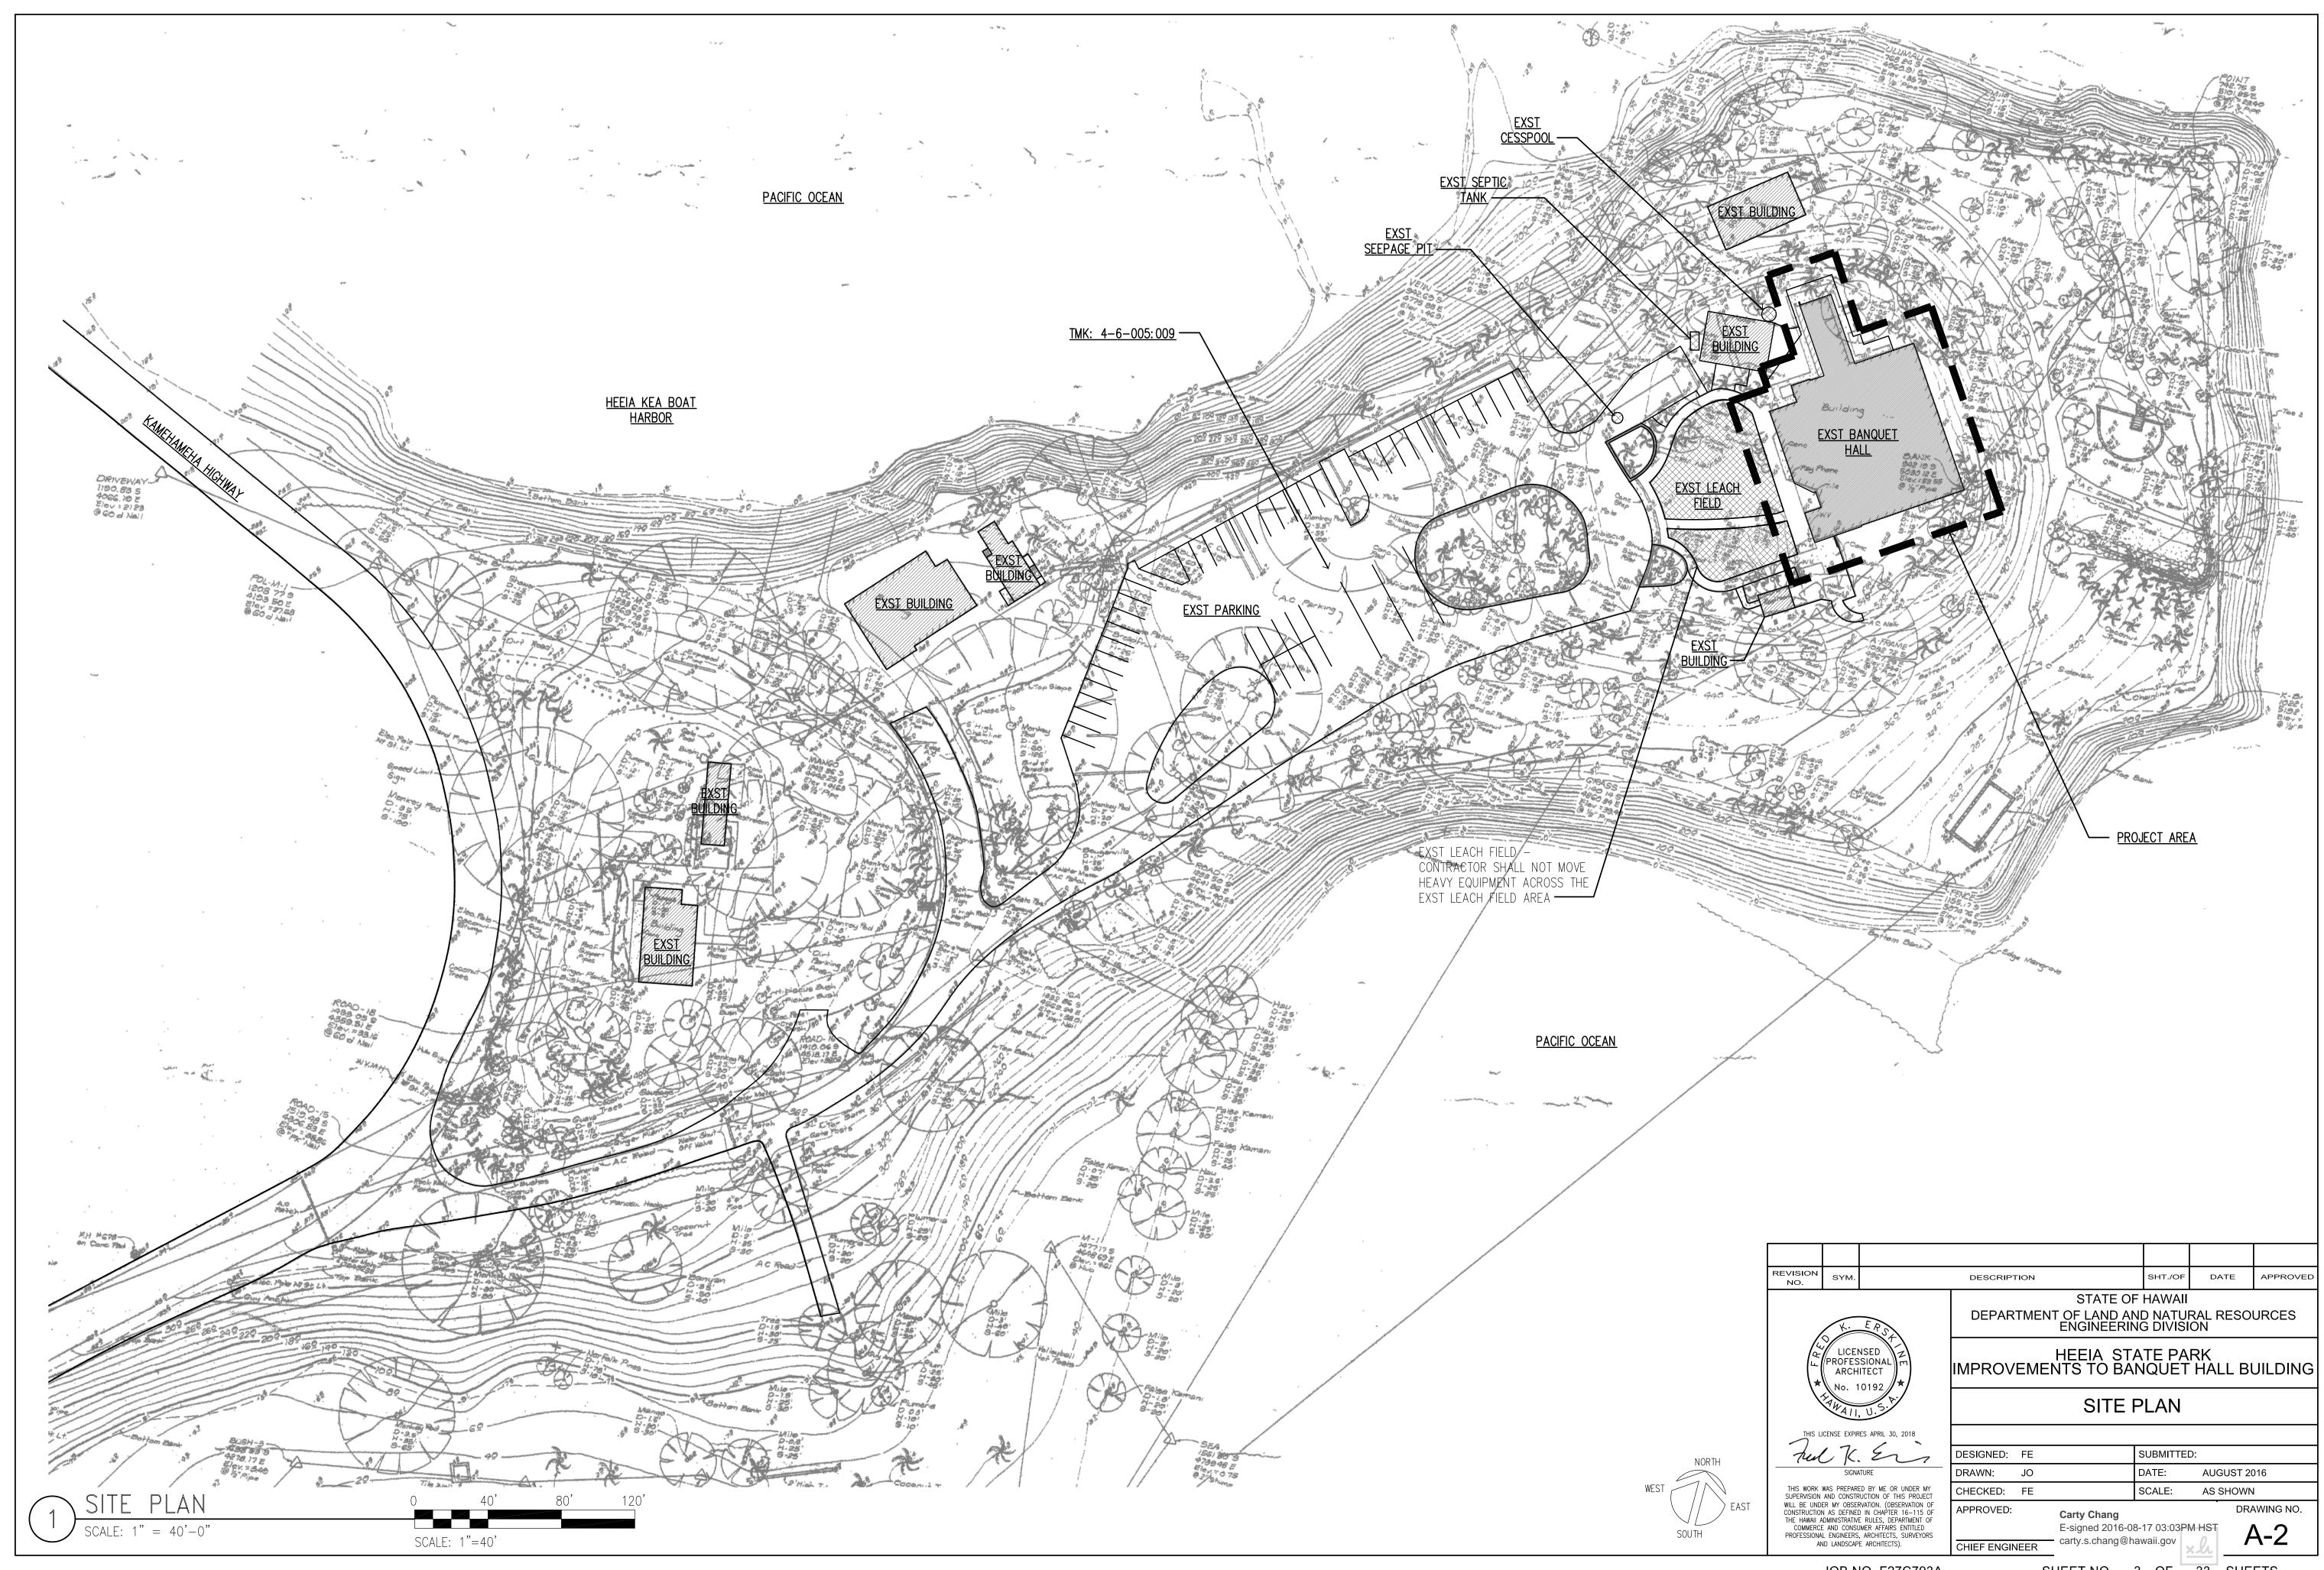

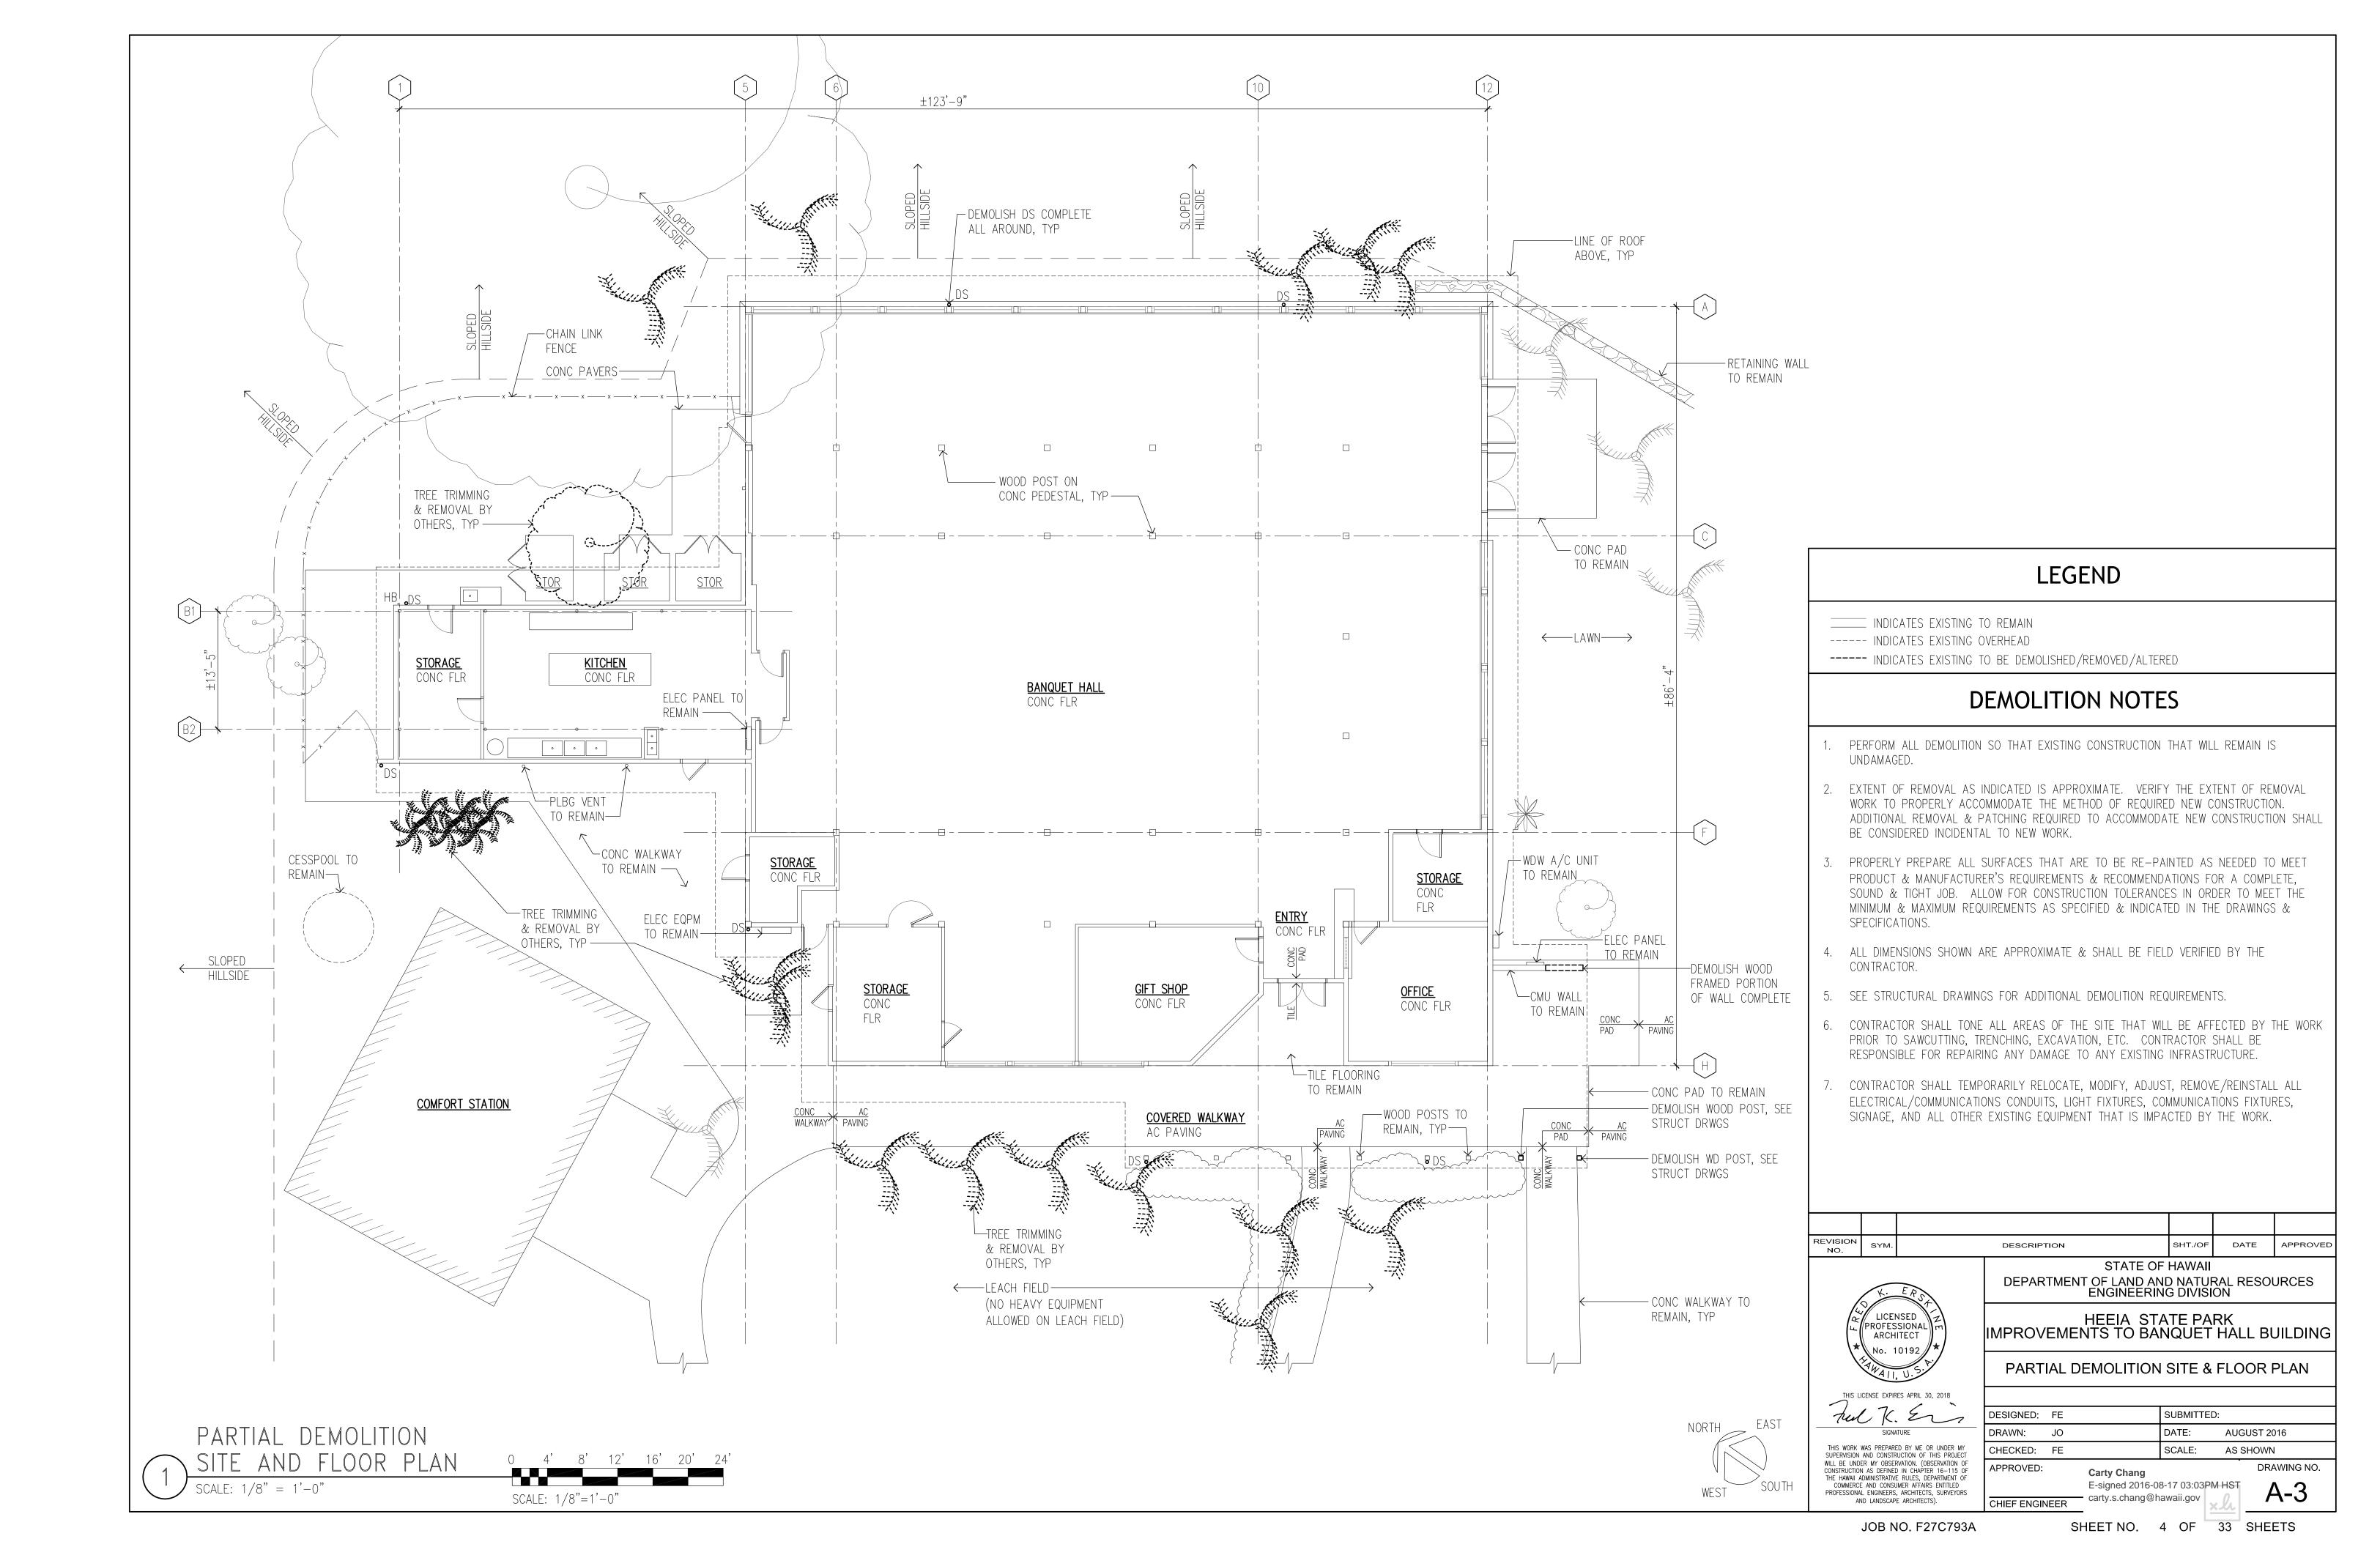

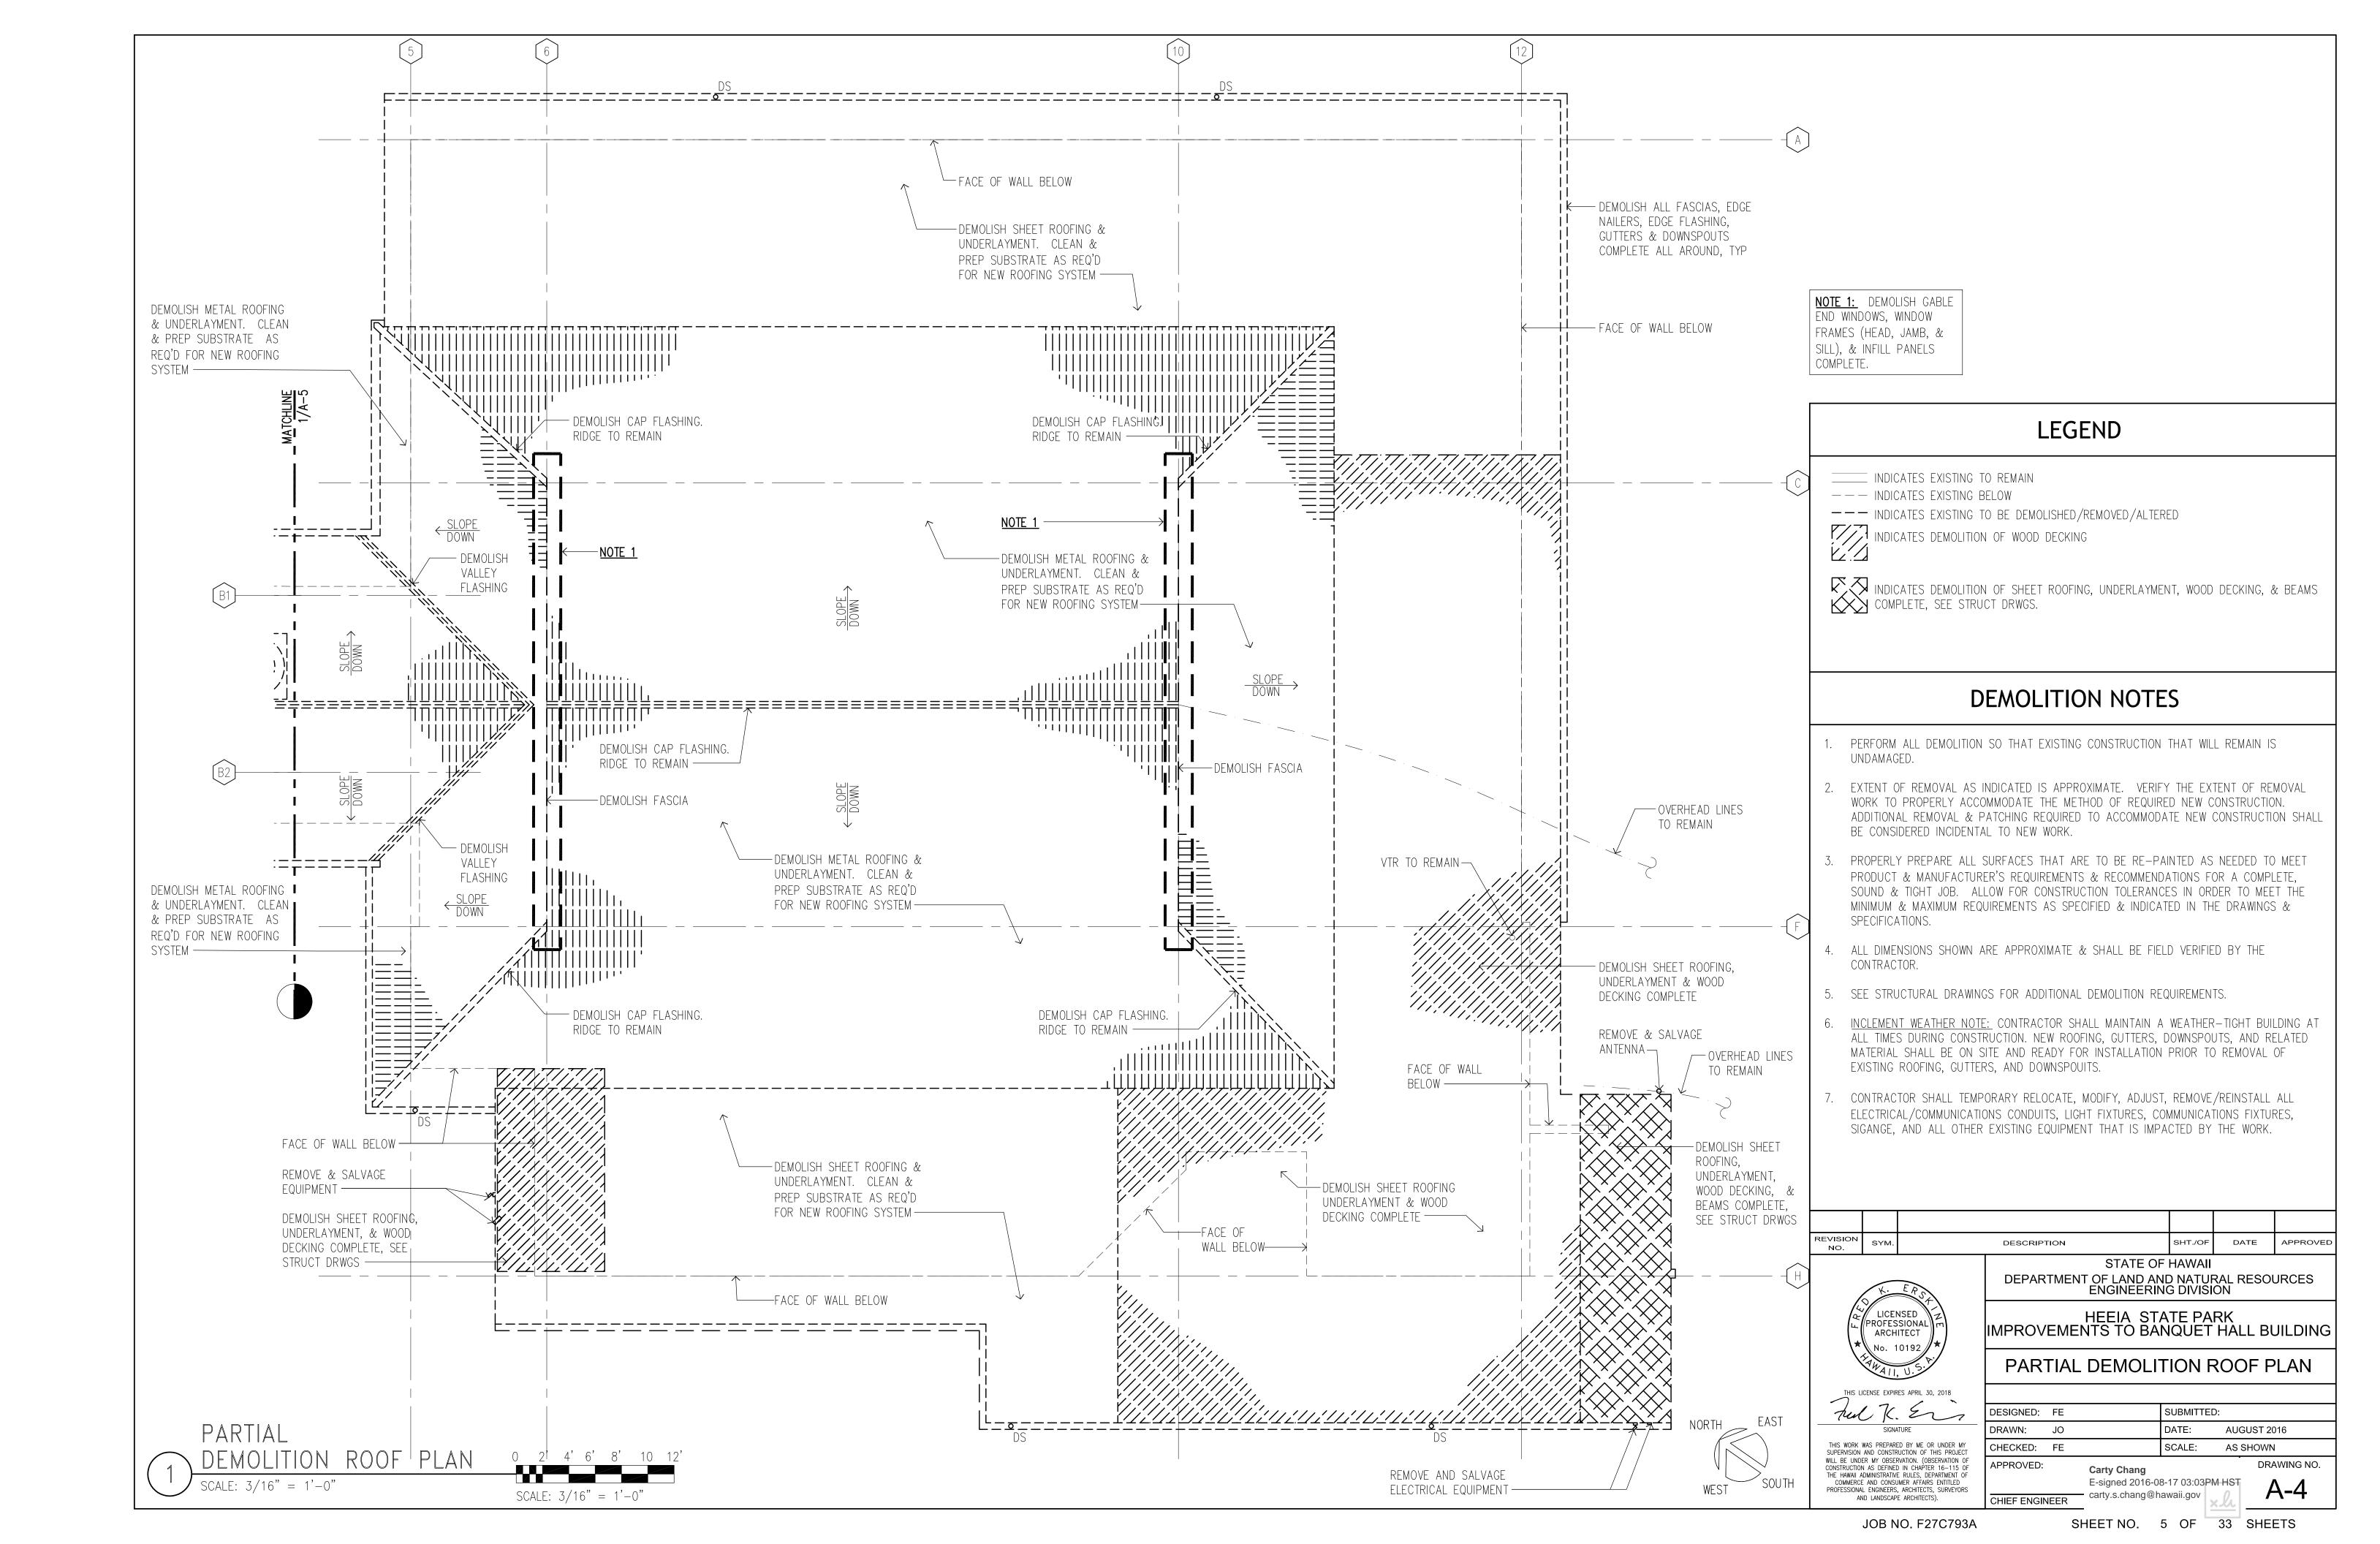

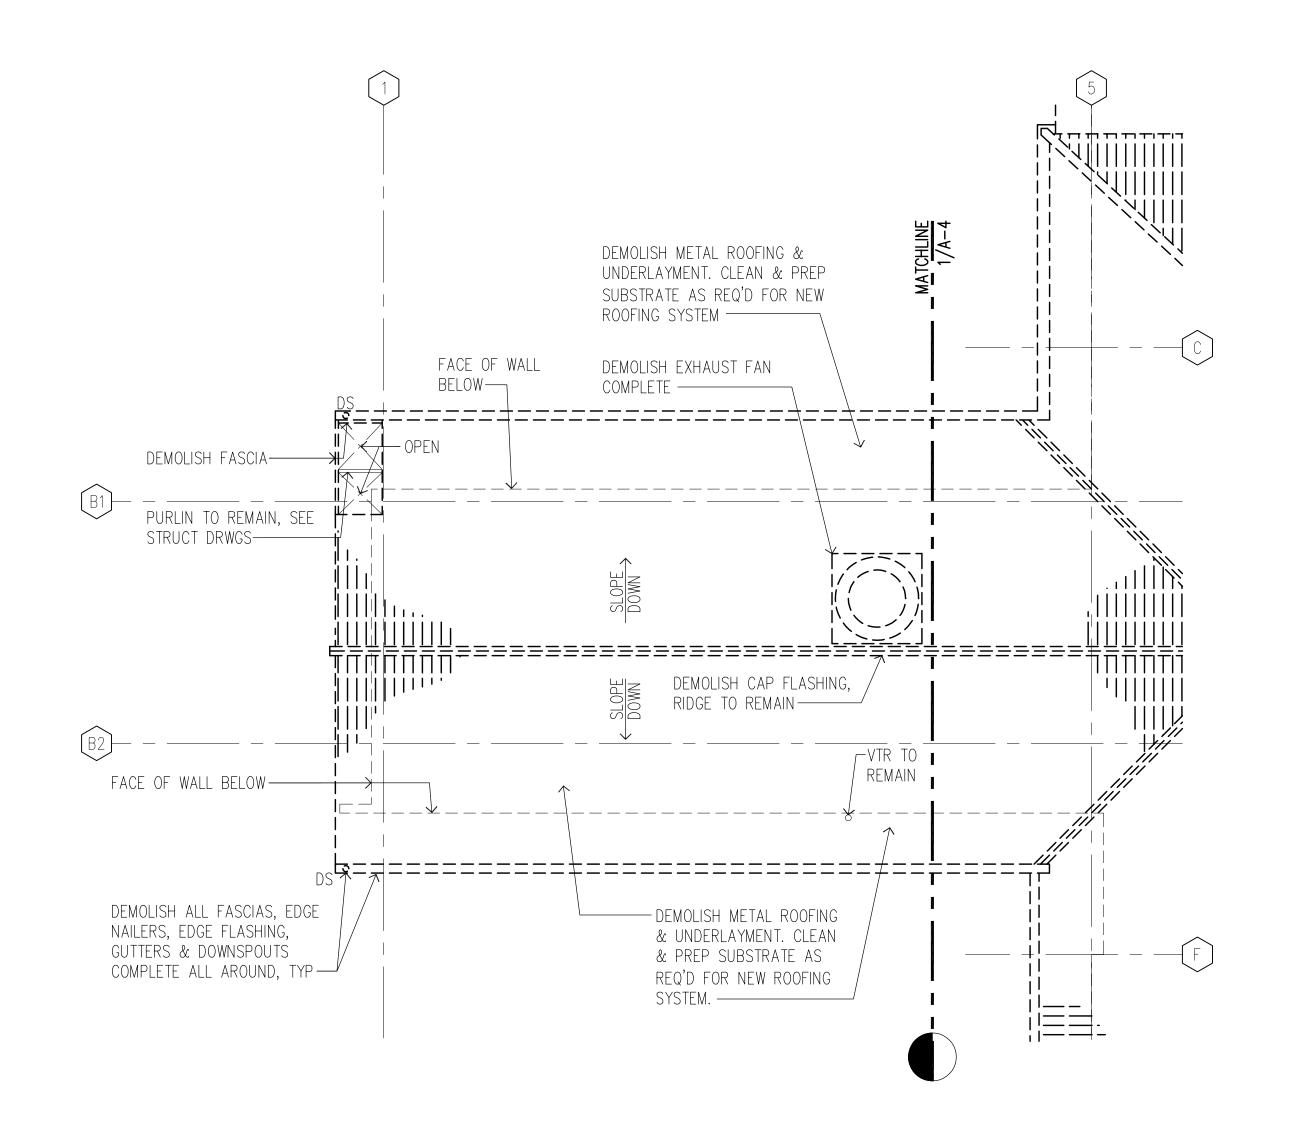

LEGEND

- _____ INDICATES EXISTING TO REMAIN
- --- Indicates existing below
- --- INDICATES EXISTING TO BE DEMOLISHED/REMOVED/ALTERED

DEMOLITION NOTES

- 1. PERFORM ALL DEMOLITION SO THAT EXISTING CONSTRUCTION THAT WILL REMAIN IS UNDAMAGED.
- 2. EXTENT OF REMOVAL AS INDICATED IS APPROXIMATE. VERIFY THE EXTENT OF REMOVAL WORK TO PROPERLY ACCOMMODATE THE METHOD OF REQUIRED NEW CONSTRUCTION. ADDITIONAL REMOVAL & PATCHING REQUIRED TO ACCOMMODATE NEW CONSTRUCTION SHALL BE CONSIDERED INCIDENTAL TO NEW WORK.
- 3. PROPERLY PREPARE ALL SURFACES THAT ARE TO BE RE-PAINTED AS NEEDED TO MEET PRODUCT & MANUFACTURER'S REQUIREMENTS & RECOMMENDATIONS FOR A COMPLETE, SOUND & TIGHT JOB. ALLOW FOR CONSTRUCTION TOLERANCES IN ORDER TO MEET THE MINIMUM & MAXIMUM REQUIREMENTS AS SPECIFIED & INDICATED IN THE DRAWINGS & SPECIFICATIONS.
- 4. ALL DIMENSIONS SHOWN ARE APPROXIMATE & SHALL BE FIELD VERIFIED BY THE CONTRACTOR.
- 5. SEE STRUCTURAL DRAWINGS FOR ADDITIONAL DEMOLITION REQUIREMENTS.
- 6. <u>INCLEMENT WEATHER NOTE:</u> CONTRACTOR SHALL MAINTAIN A WEATHER-TIGHT BUILDING AT ALL TIMES DURING CONSTRUCTION. NEW ROOFING, GUTTERS, DOWNSPOUTS, AND RELATED MATERIAL SHALL BE ON SITE AND READY FOR INSTALLATION PRIOR TO REMOVAL OF EXISTING ROOFING, GUTTERS, AND DOWNSPOUITS.
- 7. CONTRACTOR SHALL TEMPORARILY RELOCATE, MODIFY, ADJUST, REMOVE/REINSTALL ALL ELECTRICAL/COMMUNICATIONS CONDUITS, LIGHT FIXTURES, COMMUNICATIONS FIXTURES, SIGANGE, AND ALL OTHER EXISTING EQUIPMENT THAT IS IMPACTED BY THE WORK.

REVISION NO. SHT./OF DATE APPROVED DESCRIPTION STATE OF HAWAII

LICENSED PROFESSIONAL ARCHITECT THIS LICENSE EXPIRES APRIL 30, 2018

DEPARTMENT OF LAND AND NATURAL RESOURCES ENGINEERING DIVISION HEEIA STATE PARK

IMPROVEMENTS TO BANQUET HALL BUILDING

PARTIAL DEMOLITION ROOF PLAN

Aul K. Ers SUBMITTED: DESIGNED: FE DRAWN: JO DATE: AUGUST 2016 THIS WORK WAS PREPARED BY ME OR UNDER MY SUPERVISION AND CONSTRUCTION OF THIS PROJECT WILL BE UNDER MY OBSERVATION. (OBSERVATION OF SCALE: AS SHOWN CHECKED: FE DRAWING NO. APPROVED: CONSTRUCTION AS DEFINED IN CHAPTER 16-115 OF THE HAWAII ADMINISTRATIVE RULES, DEPARTMENT OF Carty Chang

CHIEF ENGINEER

EAST WEST




PARTIAL


SCALE: 3/16" = 1'-0"

A-5

E-signed 2016-08-17 03:03PM HST

carty.s.chang@hawaii.gov

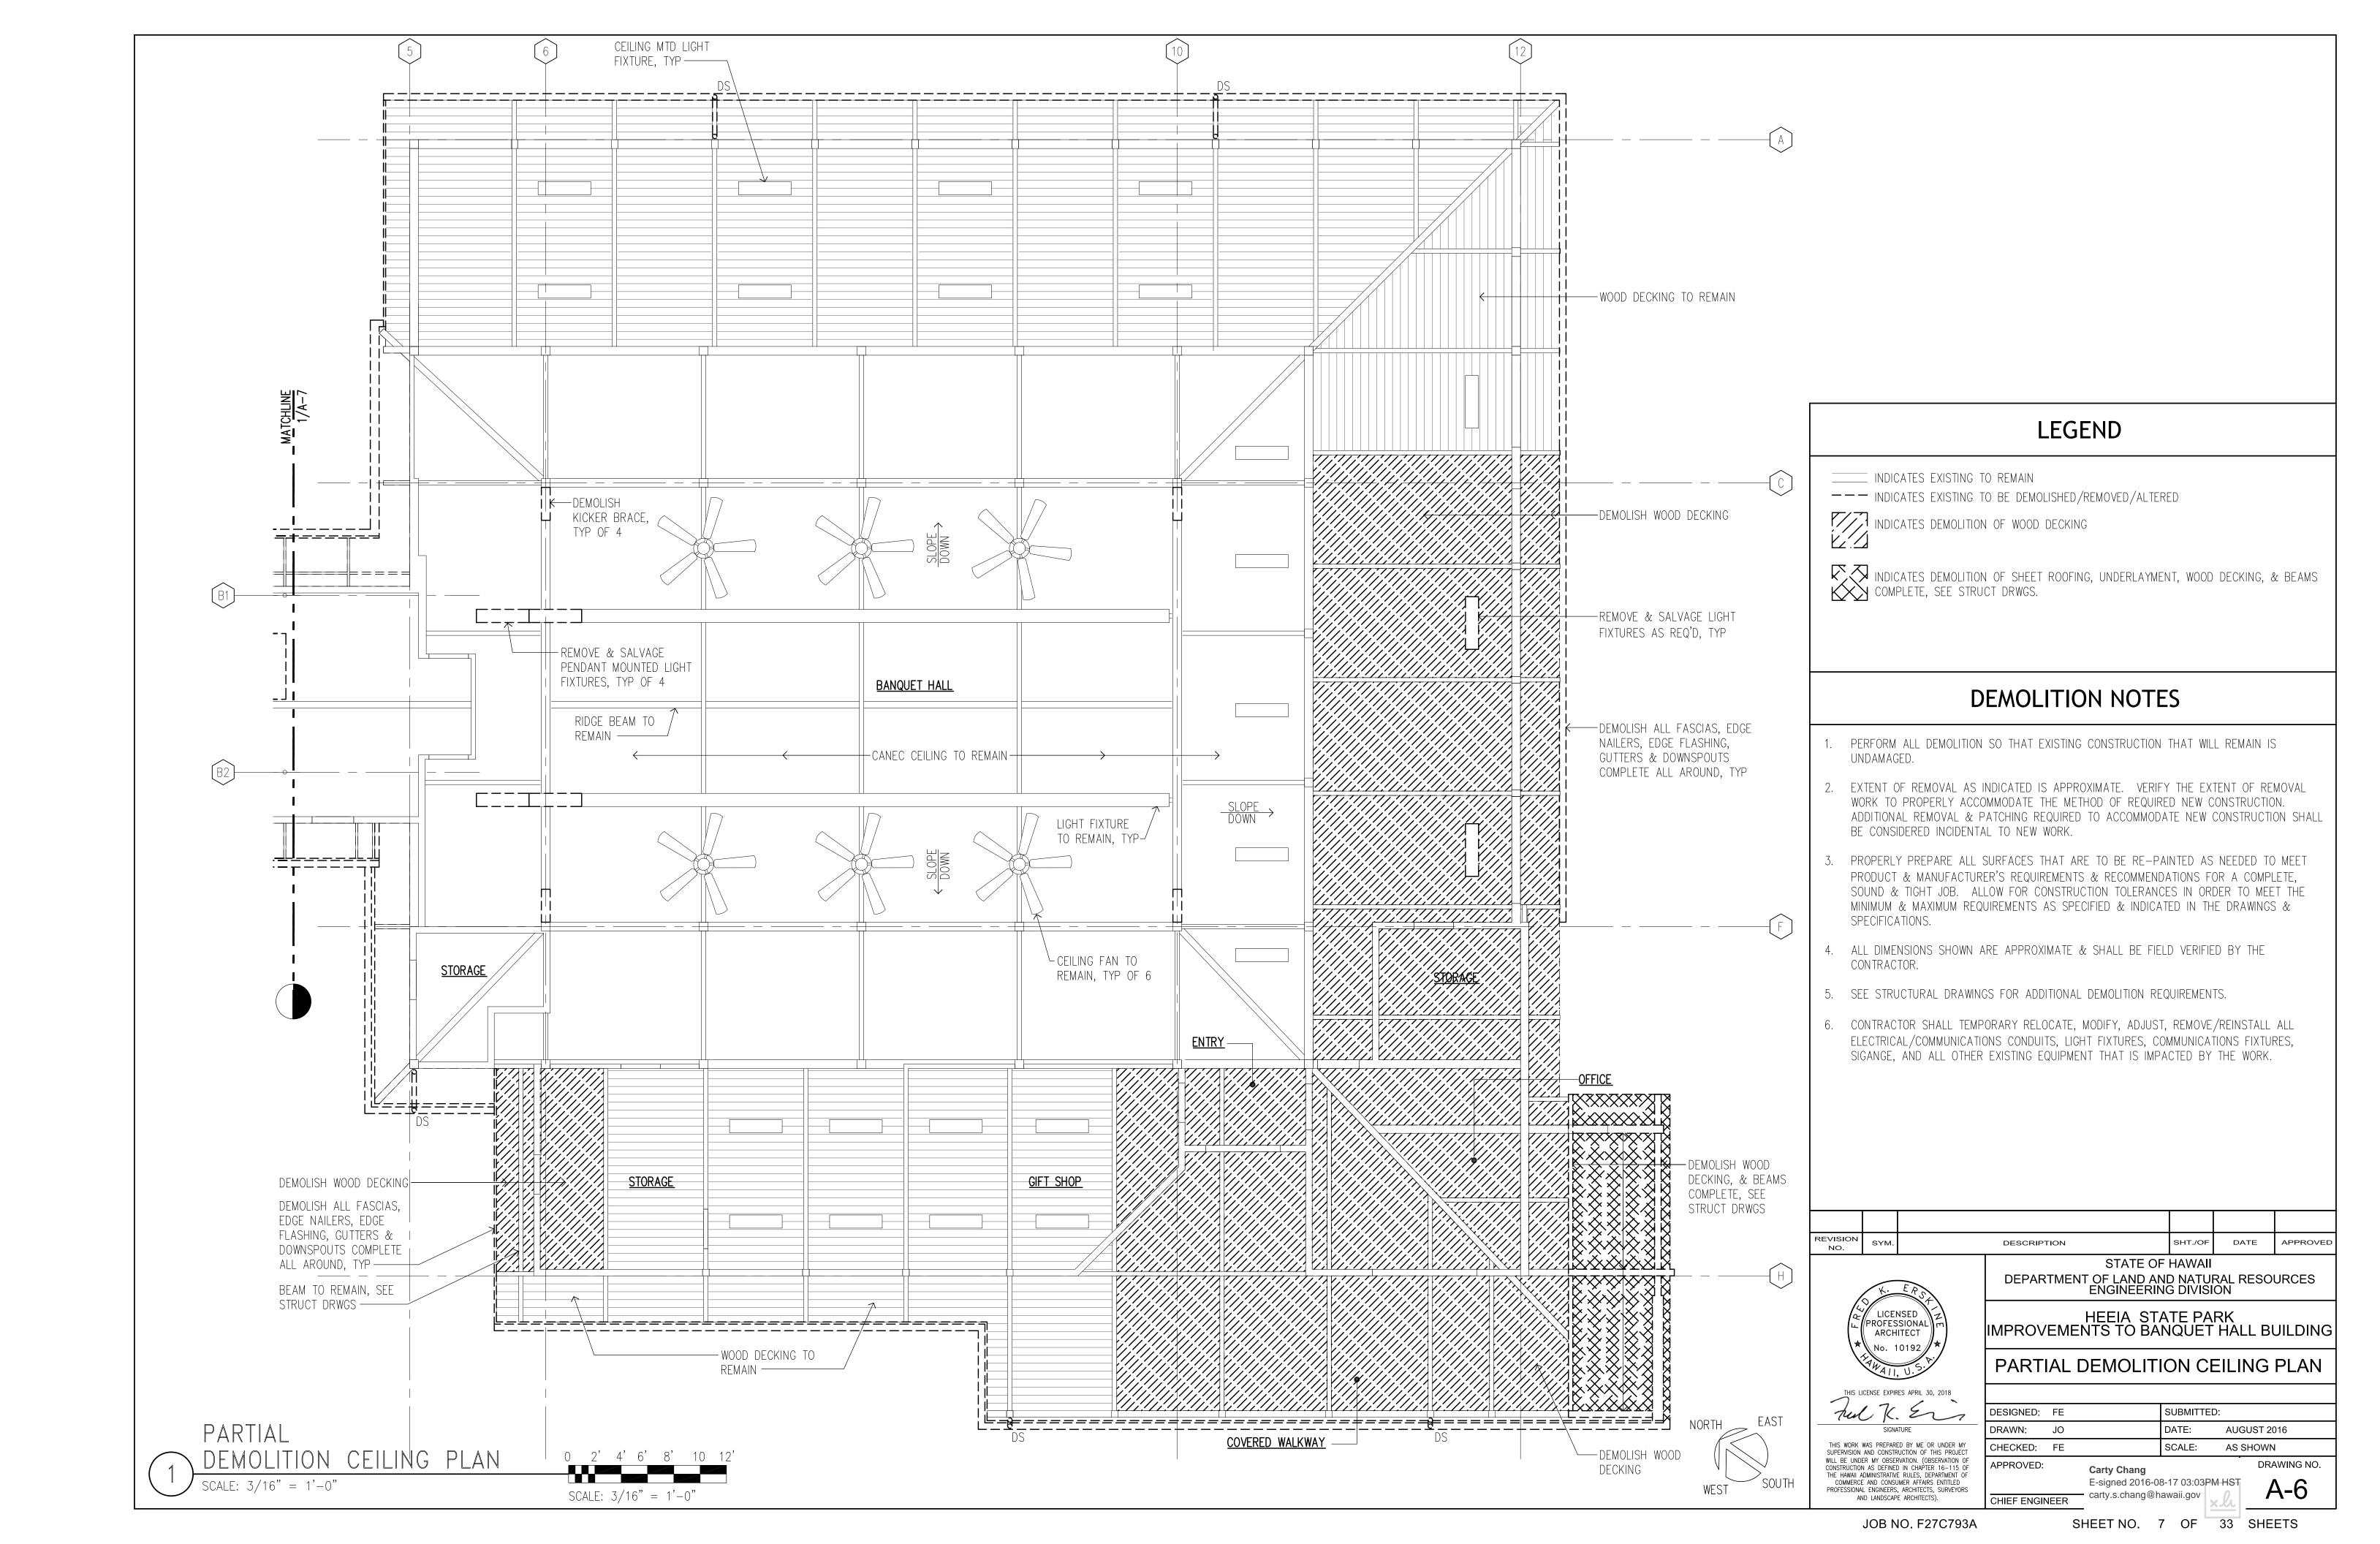

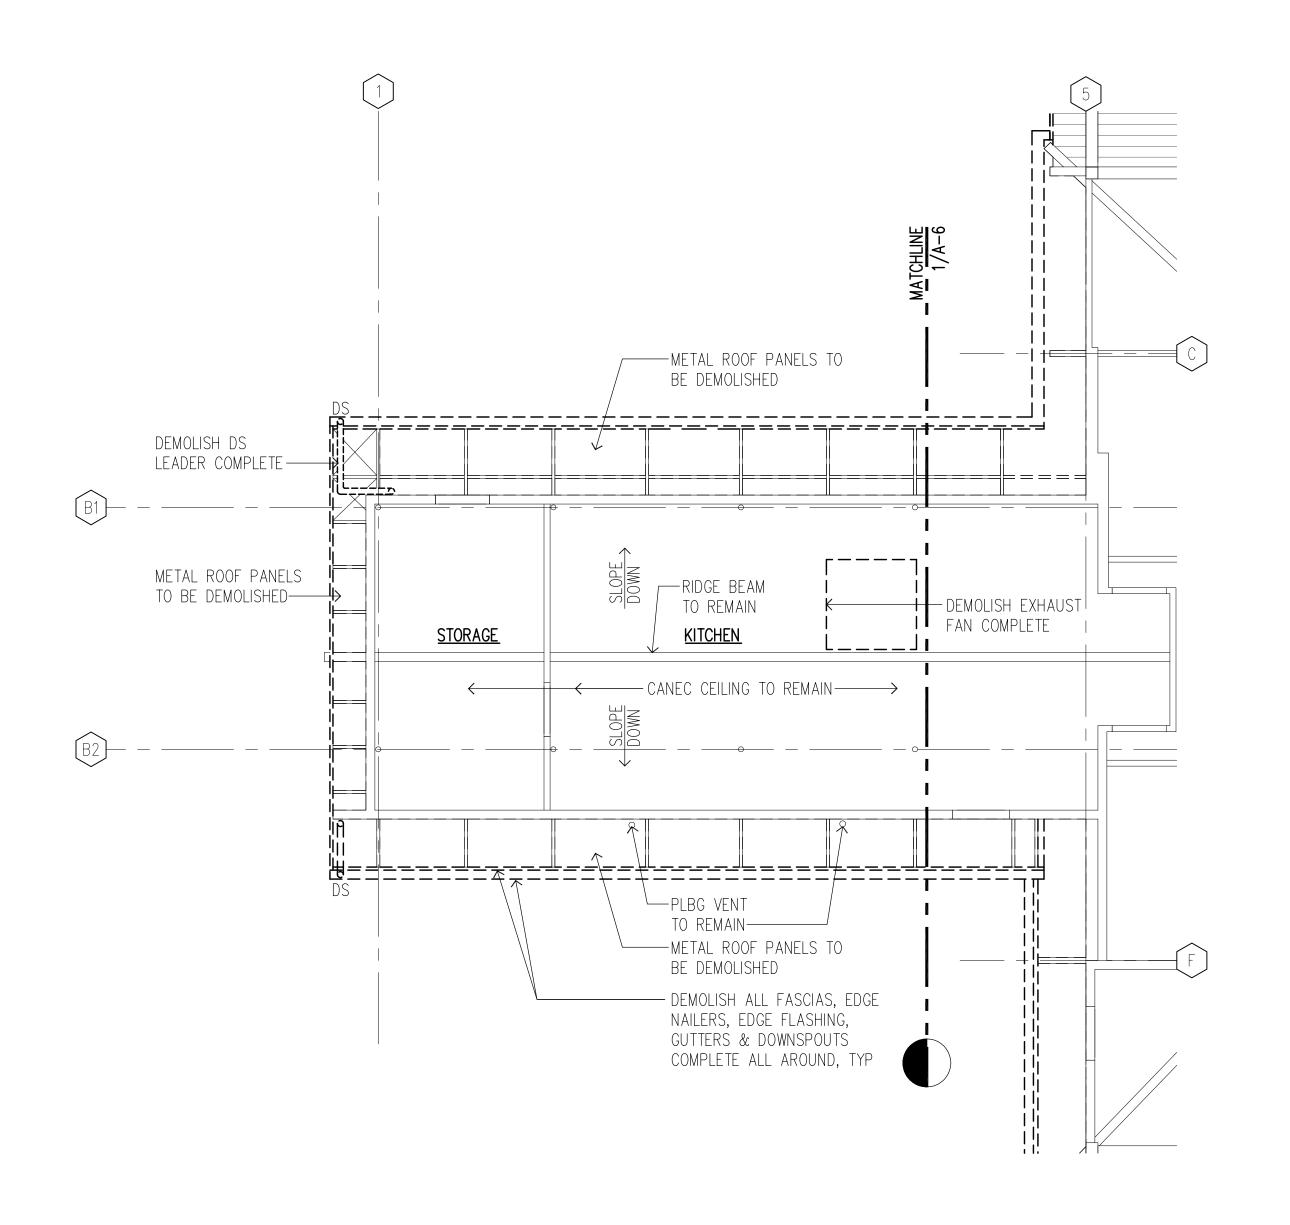

LEGEND

- _____ INDICATES EXISTING TO REMAIN
- --- INDICATES EXISTING TO BE DEMOLISHED/REMOVED/ALTERED



INDICATES DEMOLITION OF WOOD DECKING



INDICATES DEMOLITION OF SHEET ROOFING, UNDERLAYMENT, WOOD DECKING, & BEAMS COMPLETE, SEE STRUCT DRWGS.

DEMOLITION NOTES

- 1. PERFORM ALL DEMOLITION SO THAT EXISTING CONSTRUCTION THAT WILL REMAIN IS UNDAMAGED.
- 2. EXTENT OF REMOVAL AS INDICATED IS APPROXIMATE. VERIFY THE EXTENT OF REMOVAL WORK TO PROPERLY ACCOMMODATE THE METHOD OF REQUIRED NEW CONSTRUCTION. ADDITIONAL REMOVAL & PATCHING REQUIRED TO ACCOMMODATE NEW CONSTRUCTION SHALL BE CONSIDERED INCIDENTAL TO NEW WORK.
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- 4. ALL DIMENSIONS SHOWN ARE APPROXIMATE & SHALL BE FIELD VERIFIED BY THE CONTRACTOR.
- 5. SEE STRUCTURAL DRAWINGS FOR ADDITIONAL DEMOLITION REQUIREMENTS.
- 6. CONTRACTOR SHALL TEMPORARY RELOCATE, MODIFY, ADJUST, REMOVE/REINSTALL ALL ELECTRICAL/COMMUNICATIONS CONDUITS, LIGHT FIXTURES, COMMUNICATIONS FIXTURES, SIGANGE, AND ALL OTHER EXISTING EQUIPMENT THAT IS IMPACTED BY THE WORK.

REVISION NO. SHT./OF DATE APPROVED DESCRIPTION

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AND LANDSCAPE ARCHITECTS).

DEPARTMENT OF LAND AND NATURAL RESOURCES ENGINEERING DIVISION HEEIA STATE PARK

STATE OF HAWAII

IMPROVEMENTS TO BANQUET HALL BUILDING

PARTIAL DEMOLITION CEILING PLAN

Tul K. Eri SUBMITTED: DESIGNED: FE DRAWN: JO DATE: AUGUST 2016 THIS WORK WAS PREPARED BY ME OR UNDER MY SUPERVISION AND CONSTRUCTION OF THIS PROJECT WILL BE UNDER MY OBSERVATION. (OBSERVATION OF CONSTRUCTION AS DEFINED IN CHAPTER 16-115 OF THE HAWAII ADMINISTRATIVE RULES, DEPARTMENT OF SCALE: AS SHOWN CHECKED: FE DRAWING NO. Carty Chang COMMERCE AND CONSUMER AFFAIRS ENTITLED
PROFESSIONAL ENGINEERS, ARCHITECTS, SURVEYORS E-signed 2016-08-17 03:03PM HST A-7


carty.s.chang@hawaii.gov




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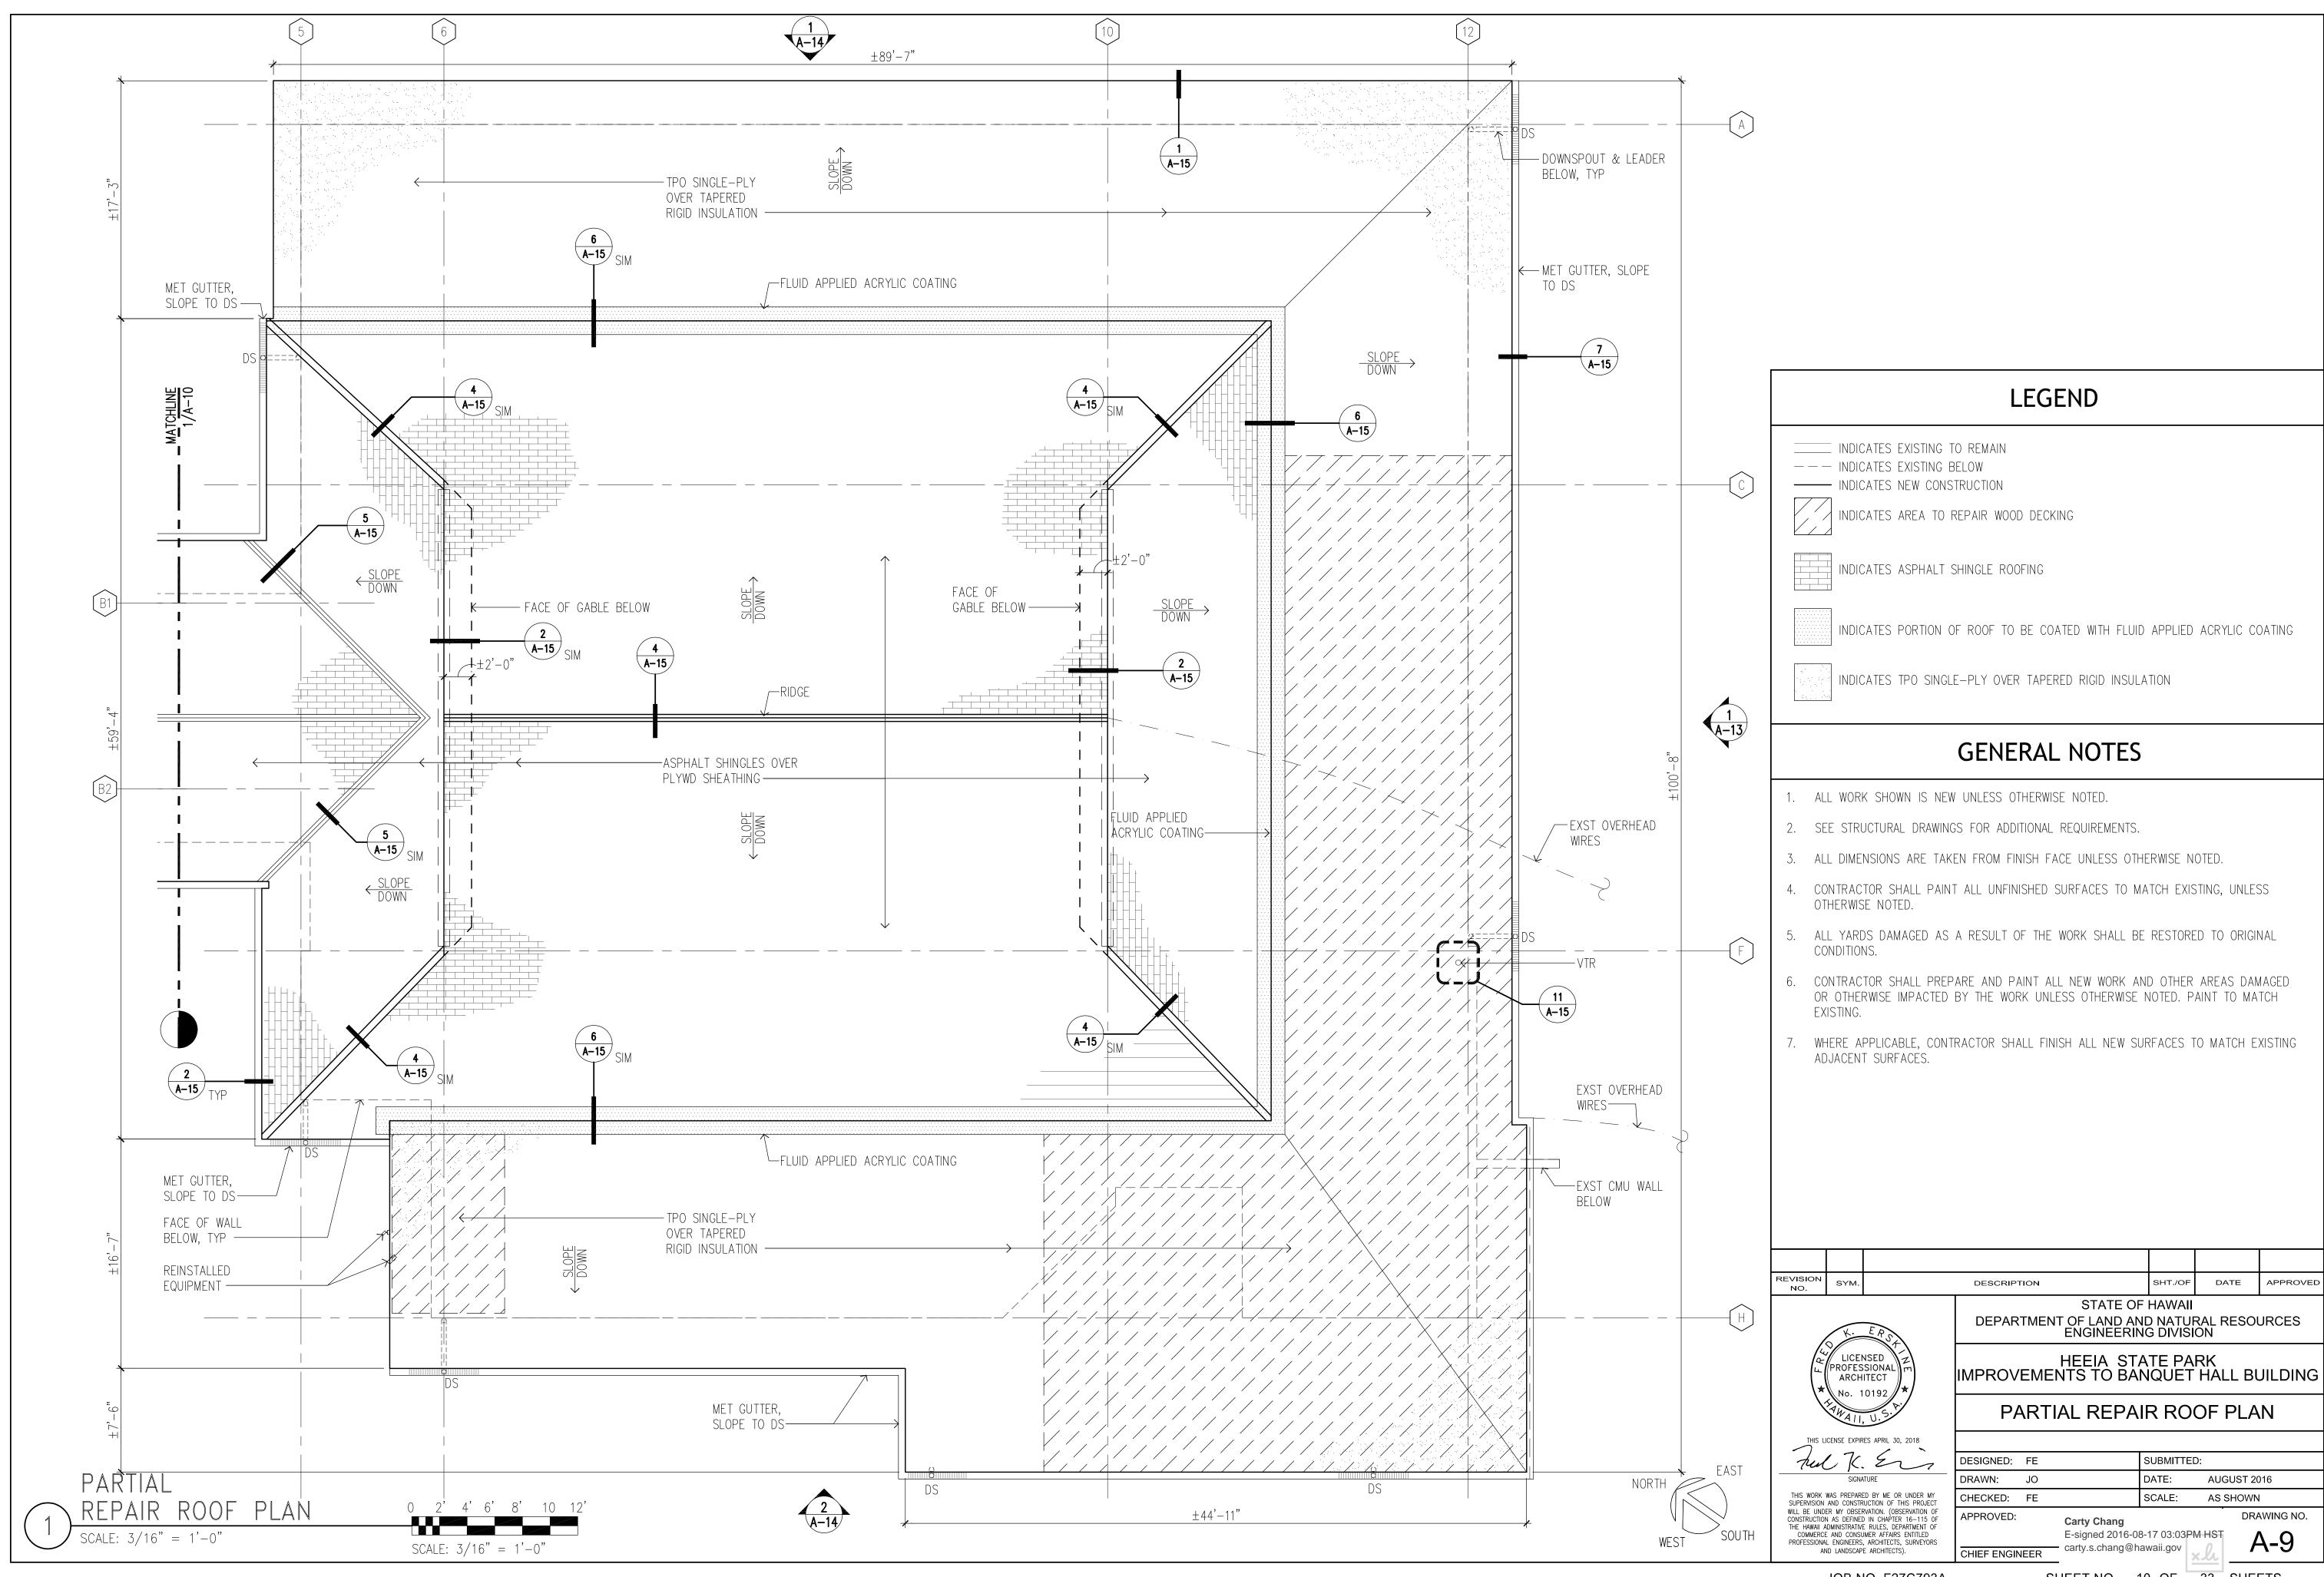
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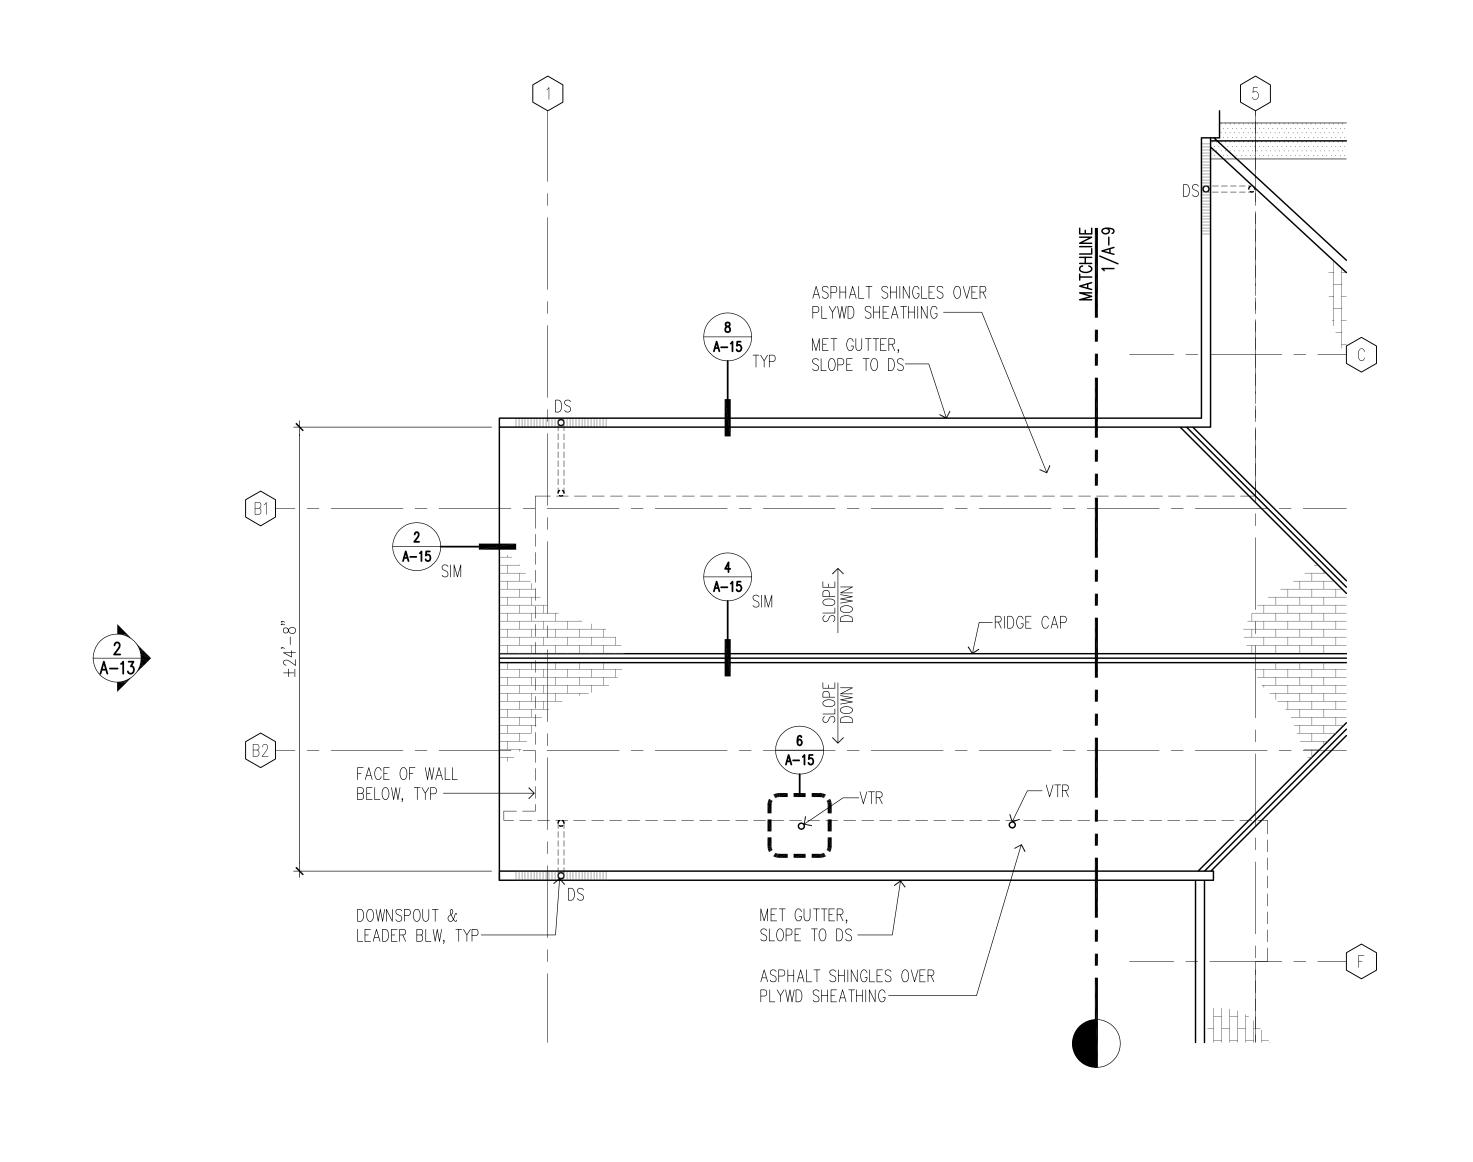
DEMOLITION CEILING PLAN



CHIEF ENGINEER

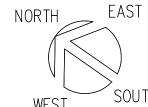



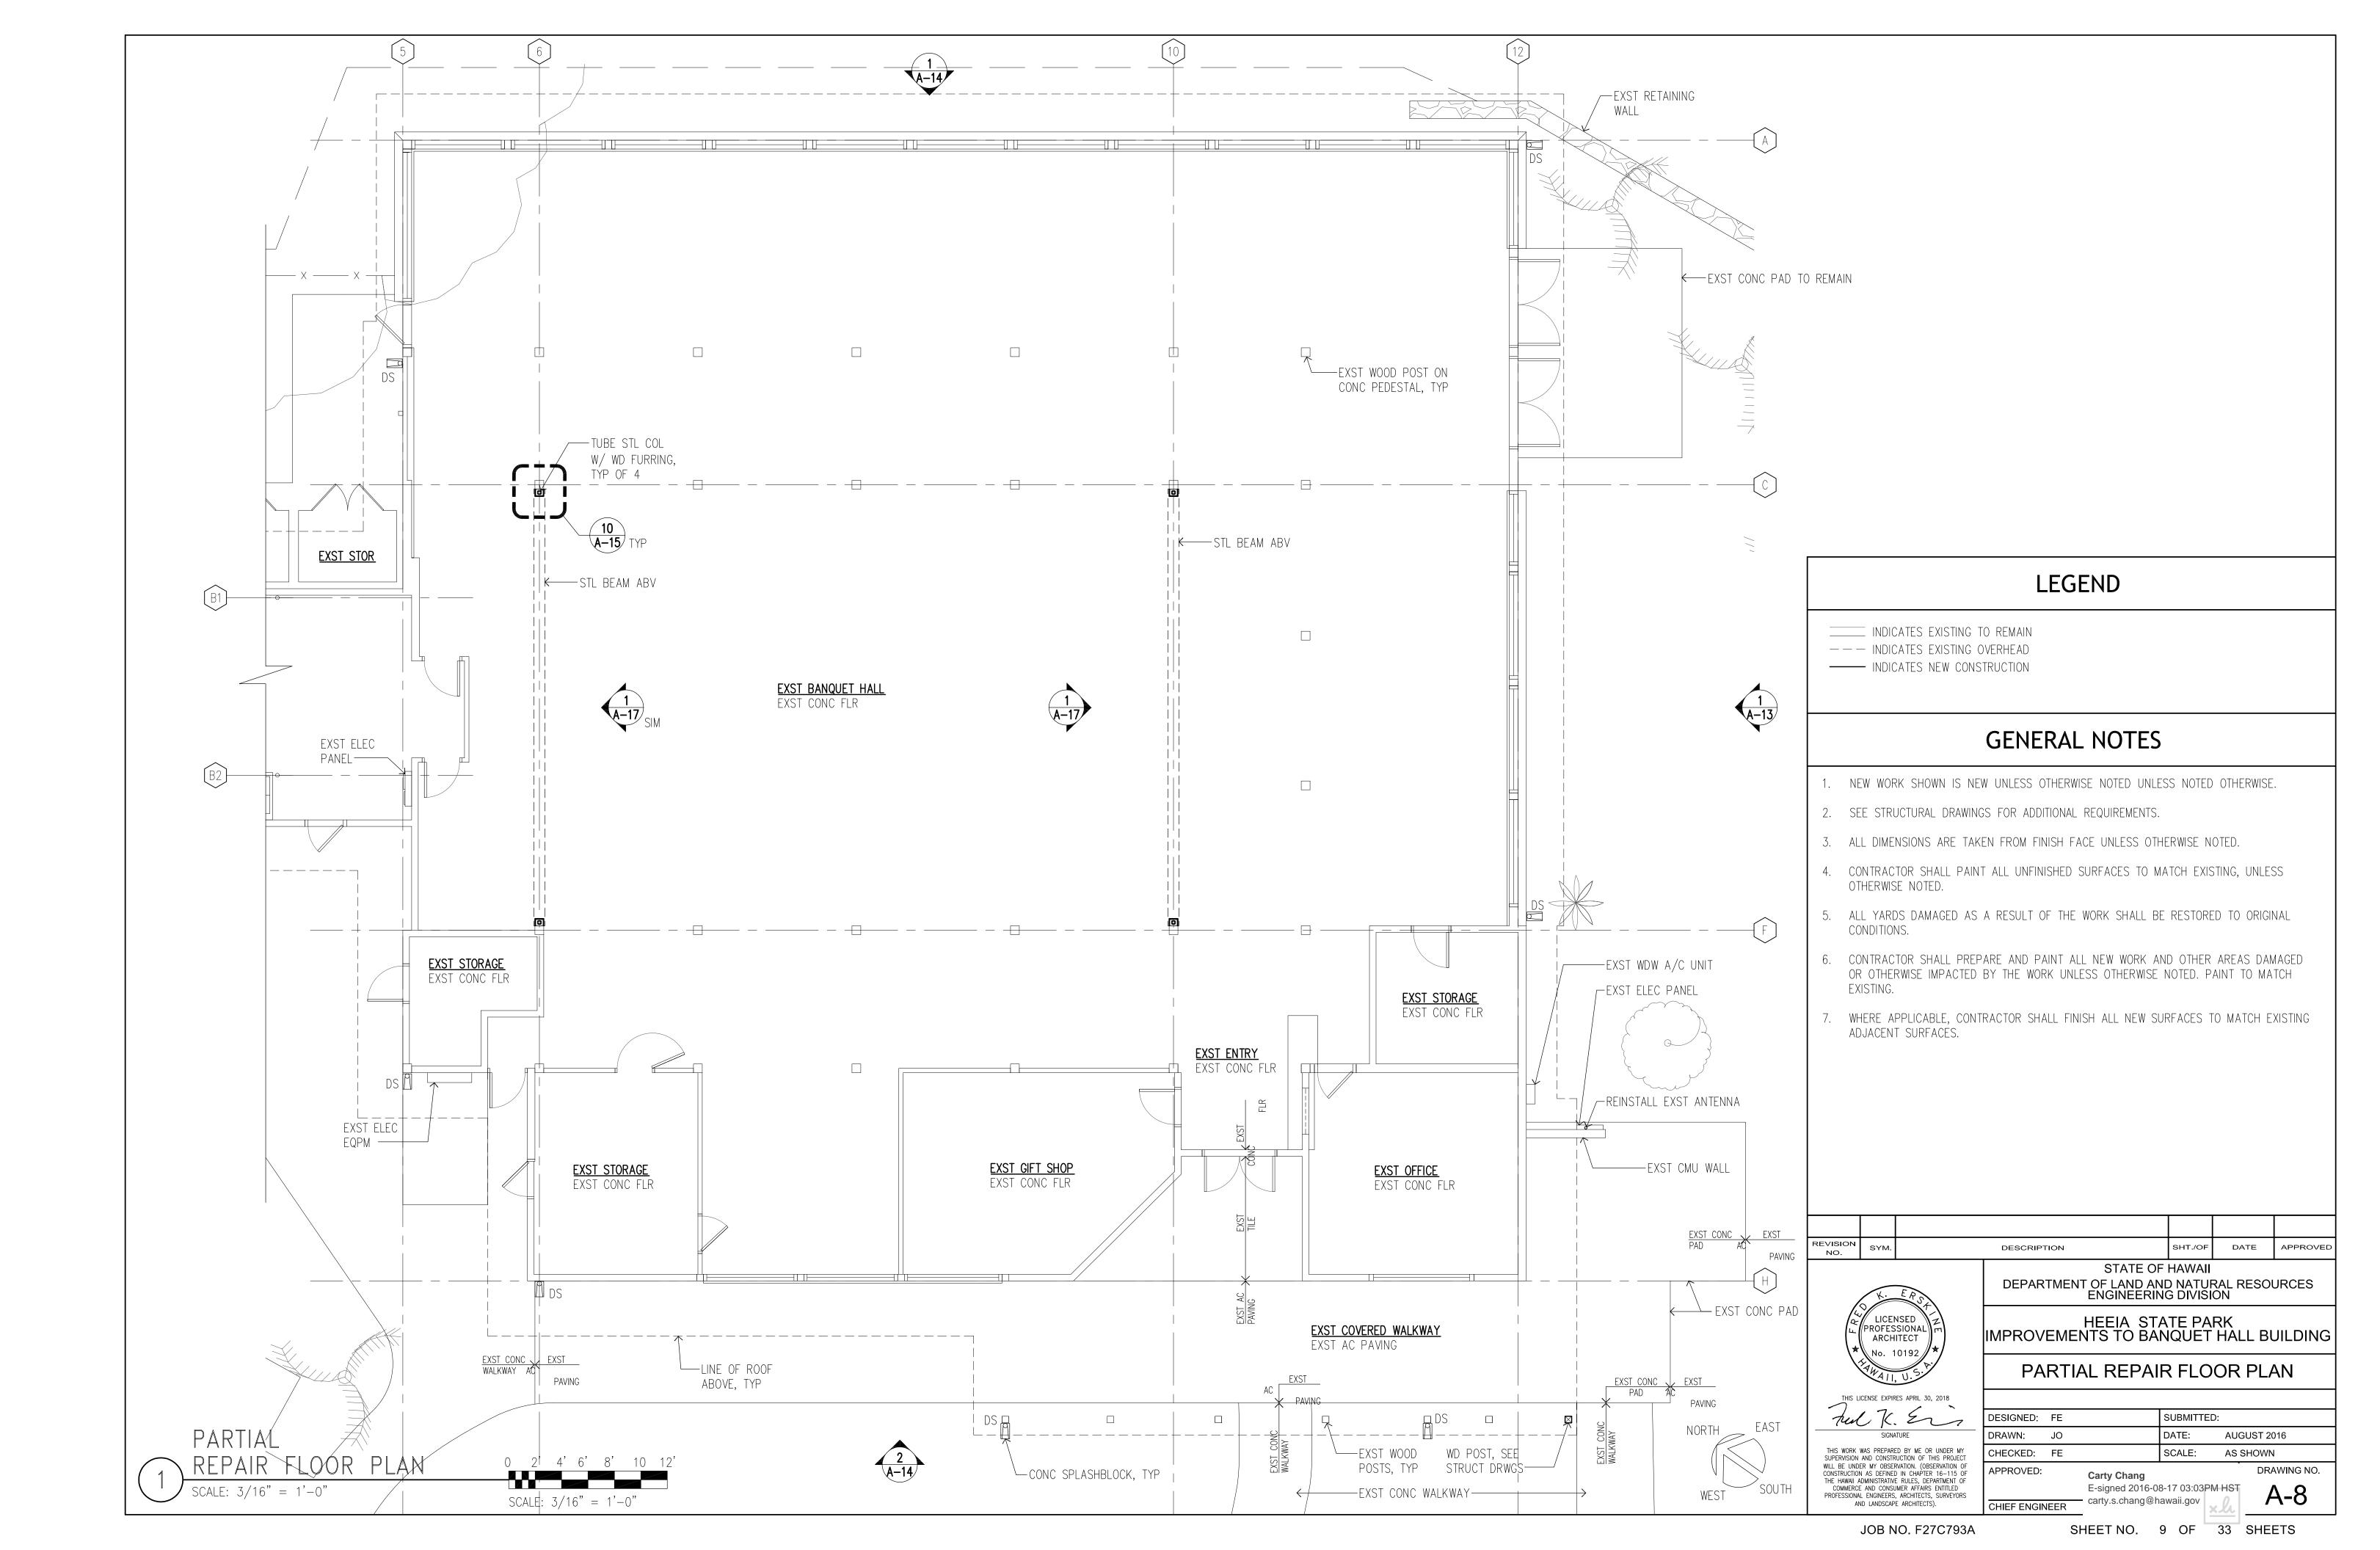

LEGEND

INDICATES EXISTING TO REMAIN

--- INDICATES EXISTING BELOW

----- INDICATES NEW CONSTRUCTION INDICATES AREA TO REPAIR WOOD DECKING

INDICATES ASPHALT SHINGLES

INDICATES PORTION OF ROOF TO BE COATED WITH FLUID APPLIED ACRYLIC COATING

GENERAL NOTES

- 1. ALL WORK SHOWN IS NEW UNLESS OTHERWISE NOTED.
- 2. SEE STRUCTURAL DRAWINGS FOR ADDITIONAL REQUIREMENTS.
- 3. ALL DIMENSIONS ARE TAKEN FROM FINISH FACE UNLESS OTHERWISE NOTED.
- 4. CONTRACTOR SHALL PAINT ALL UNFINISHED SURFACES TO MATCH EXISTING, UNLESS OTHERWISE NOTED.
- 5. ALL YARDS DAMAGED AS A RESULT OF THE WORK SHALL BE RESTORED TO ORIGINAL CONDITIONS.
- 6. CONTRACTOR SHALL PREPARE AND PAINT ALL NEW WORK AND OTHER AREAS DAMAGED OR OTHERWISE IMPACTED BY THE WORK UNLESS OTHERWISE NOTED. PAINT TO MATCH
- 7. WHERE APPLICABLE, CONTRACTOR SHALL FINISH ALL NEW SURFACES TO MATCH EXISTING ADJACENT SURFACES.

REVISION NO. SHT./OF DATE APPROVED DESCRIPTION STATE OF HAWAII

LICENSED PROFESSIONAL ARCHITECT

HEEIA STATE PARK IMPROVEMENTS TO BANQUET HALL BUILDING

PARTIAL REPAIR ROOF PLAN

DEPARTMENT OF LAND AND NATURAL RESOURCES ENGINEERING DIVISION


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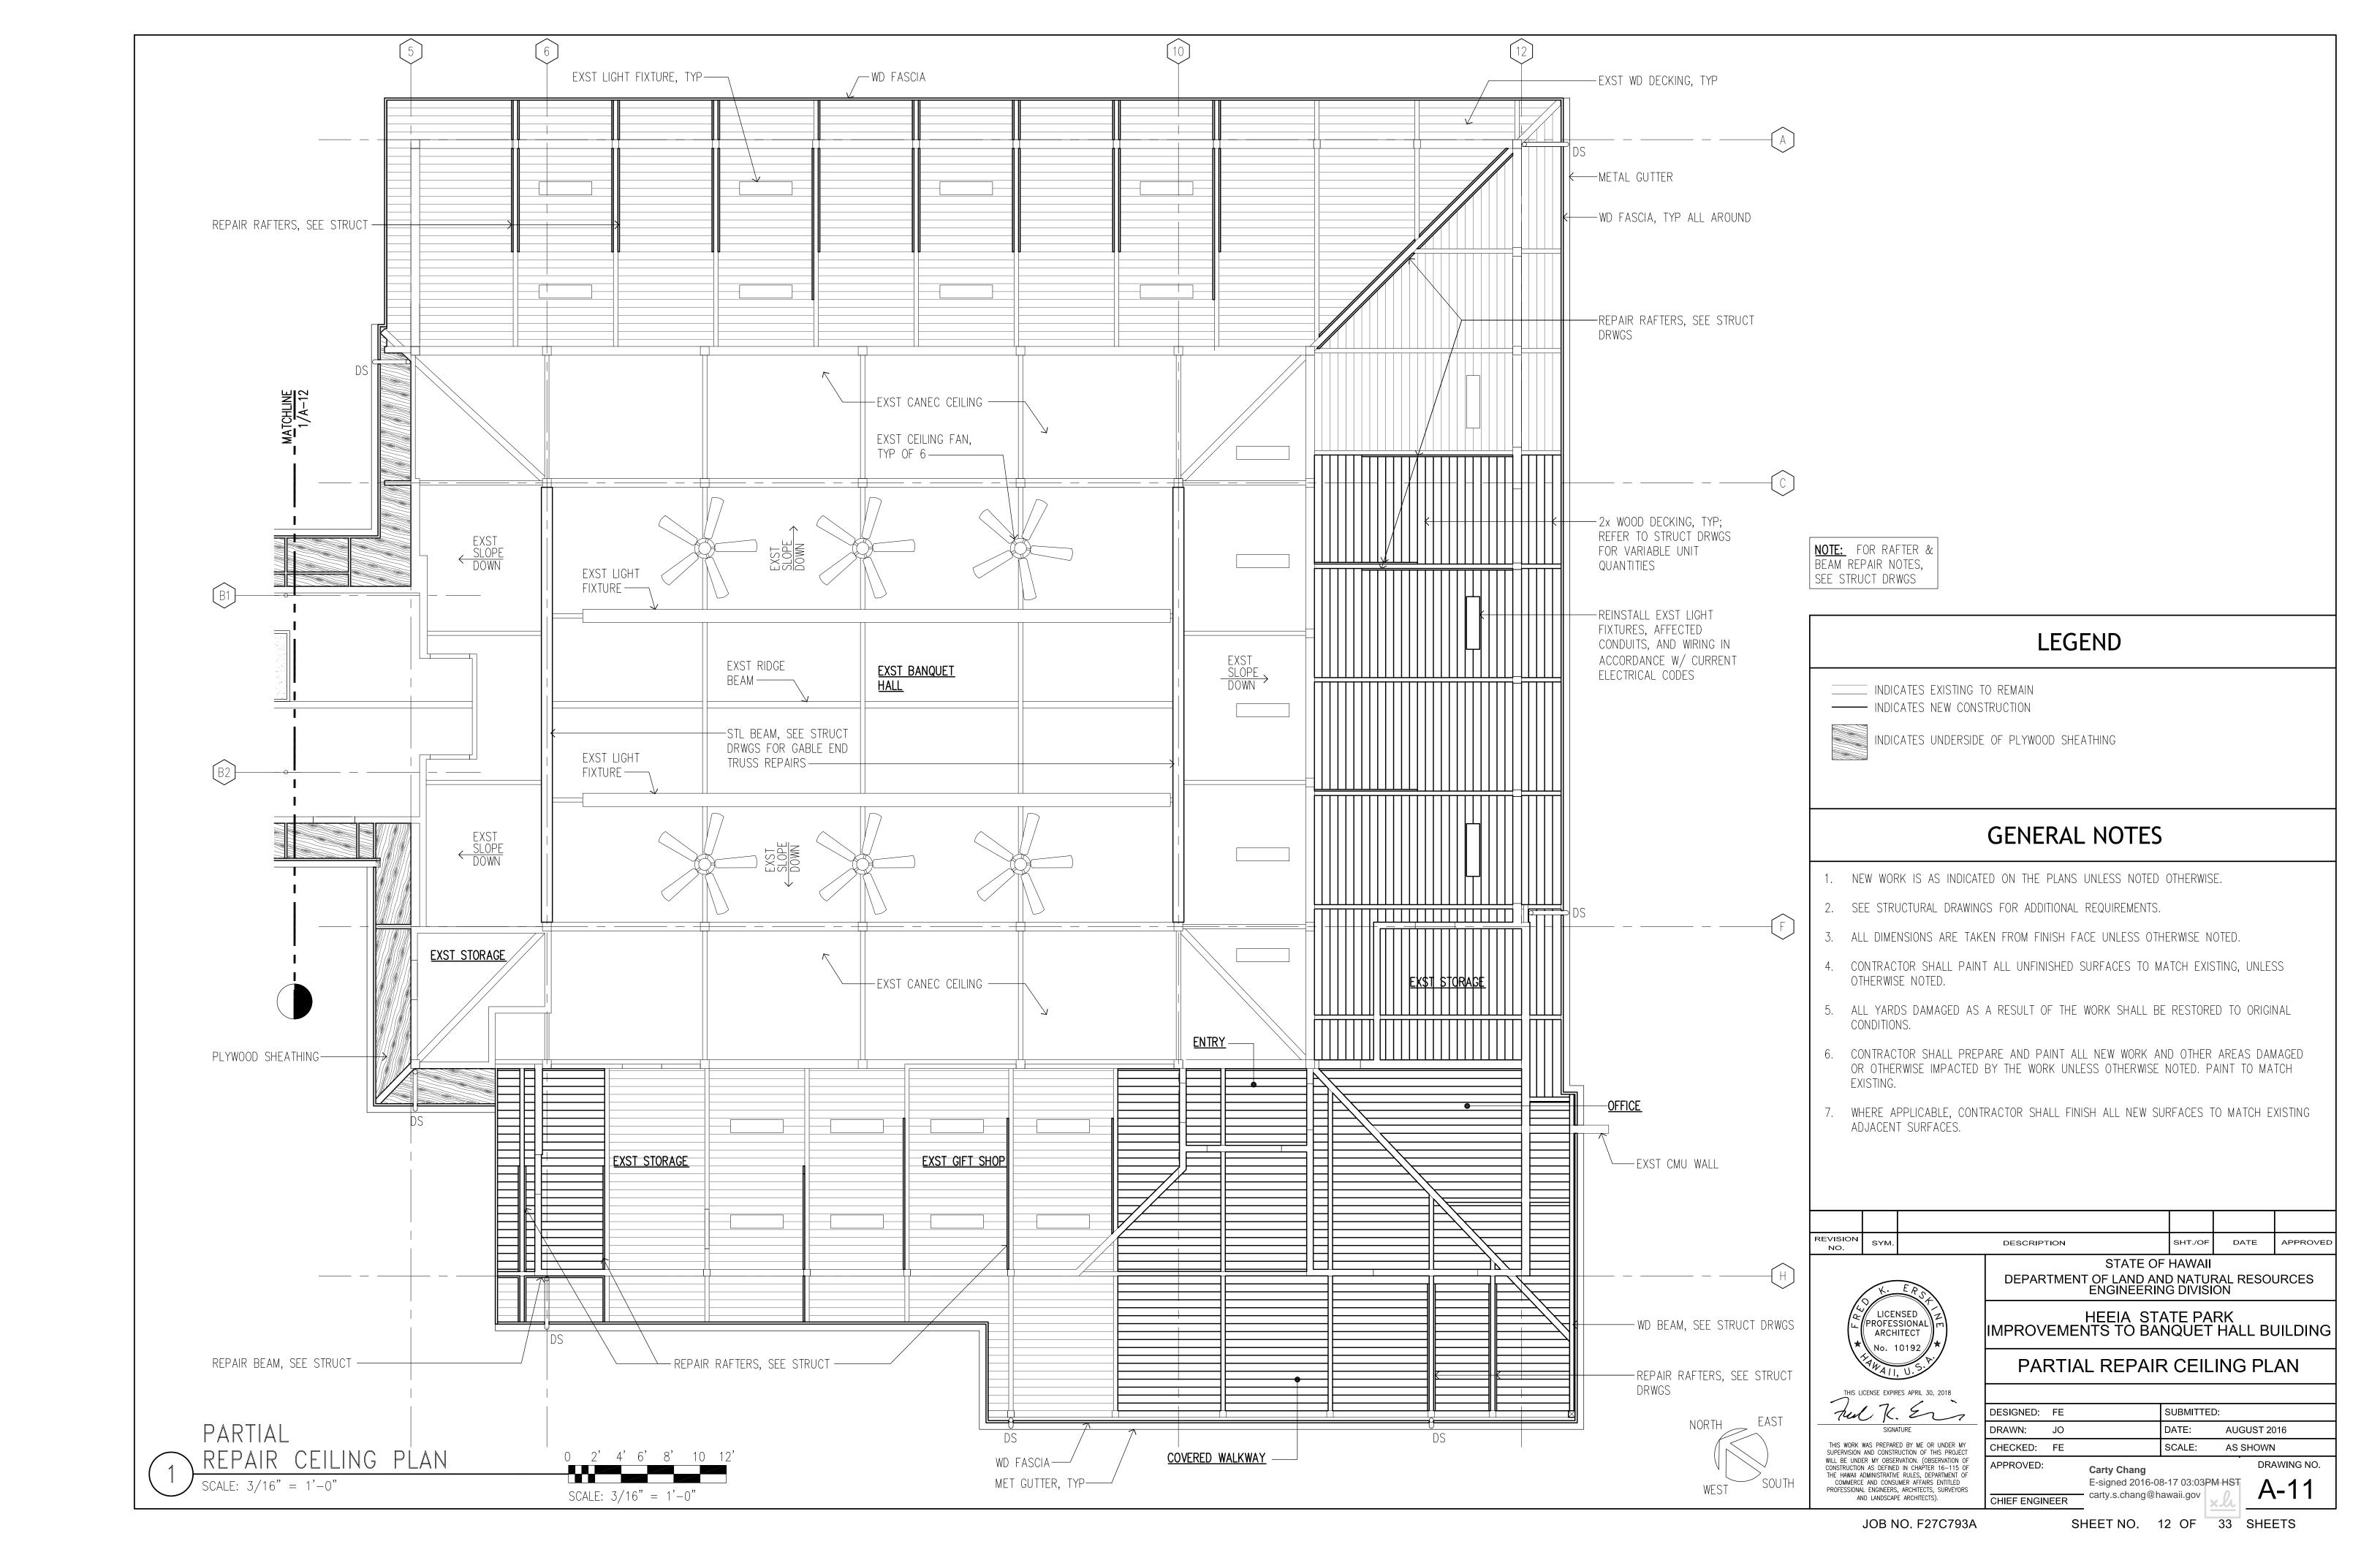
Carty Chang E-signed 2016-08-17 03:03PM HST carty.s.chang@hawaii.gov CHIEF ENGINEER


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EAST

PARTIAL SCALE: 3/16" = 1'-0"





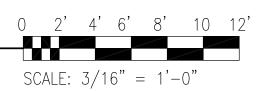

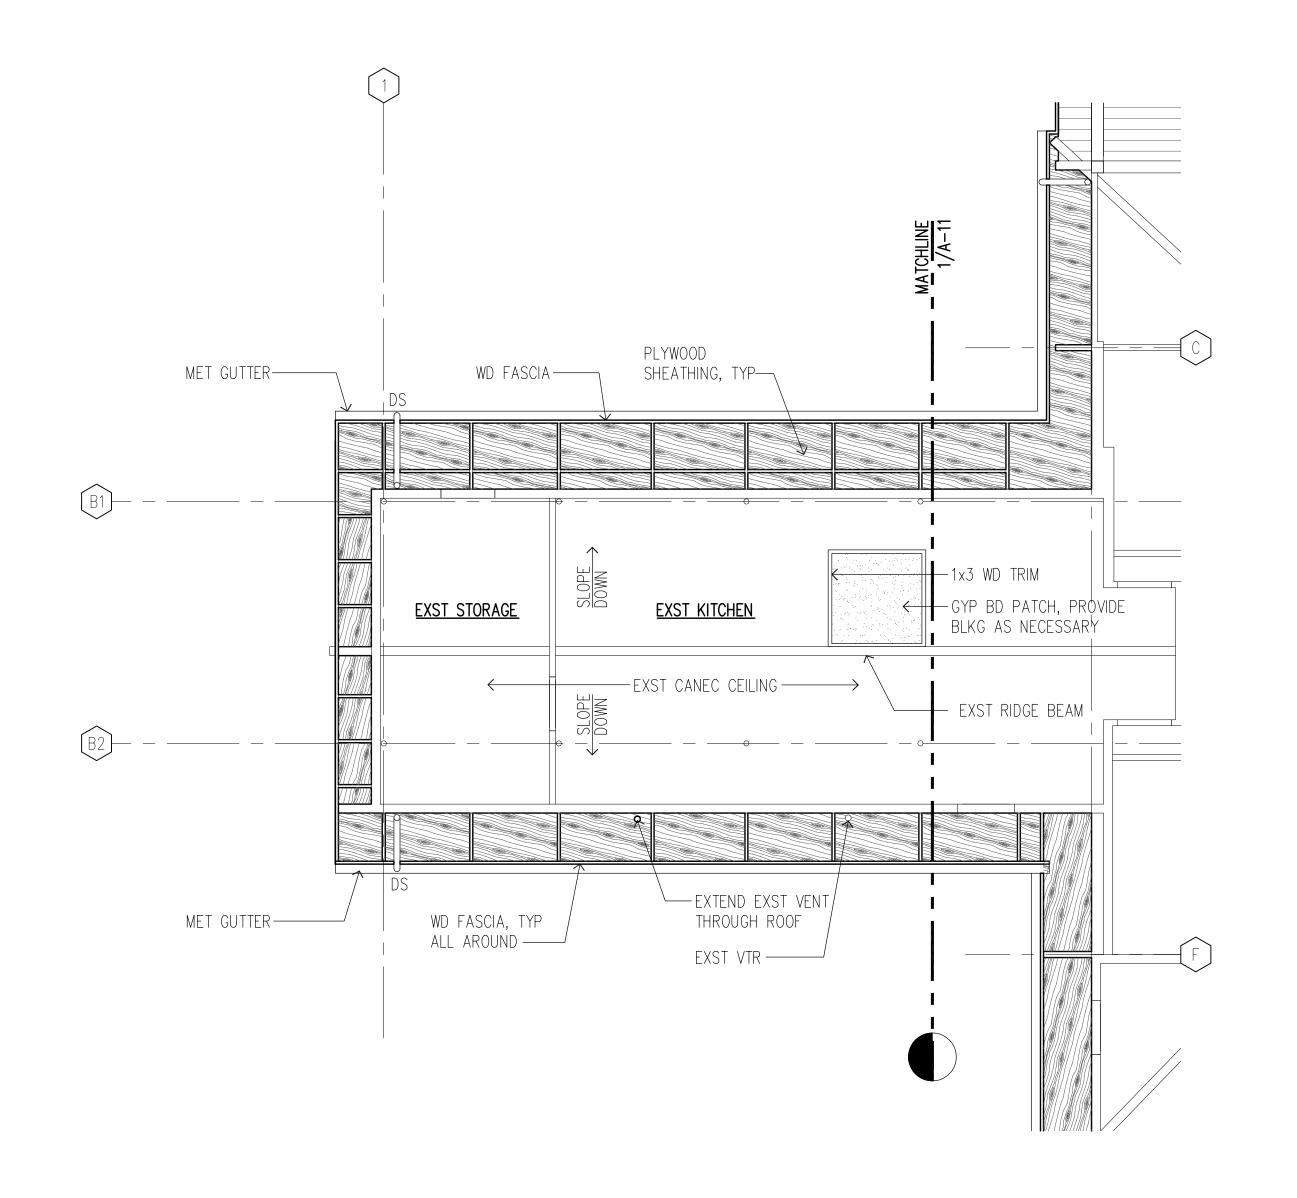NOTE: FOR RAFTER & BEAM REPAIR NOTES, SEE STRUCT DRWGS

LEGEND

____ INDICATES EXISTING TO REMAIN ----- INDICATES NEW CONSTRUCTION



INDICATES UNDERSIDE OF PLYWOOD SHEATHING



INDICATES 5" THK TYPE "X" GYP BD

GENERAL NOTES

- 1. NEW WORK SHOWN IS NEW UNLESS OTHERWISE NOTED UNLESS NOTED OTHERWISE.
- 2. SEE STRUCTURAL DRAWINGS FOR ADDITIONAL REQUIREMENTS.
- 3. ALL DIMENSIONS ARE TAKEN FROM FINISH FACE UNLESS OTHERWISE NOTED.
- 4. CONTRACTOR SHALL PAINT ALL UNFINISHED SURFACES TO MATCH EXISTING, UNLESS OTHERWISE NOTED.
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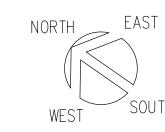
DEPARTMENT OF LAND AND NATURAL RESOURCES ENGINEERING DIVISION

HEEIA STATE PARK IMPROVEMENTS TO BANQUET HALL BUILDING


PARTIAL REPAIR CEILING PLAN

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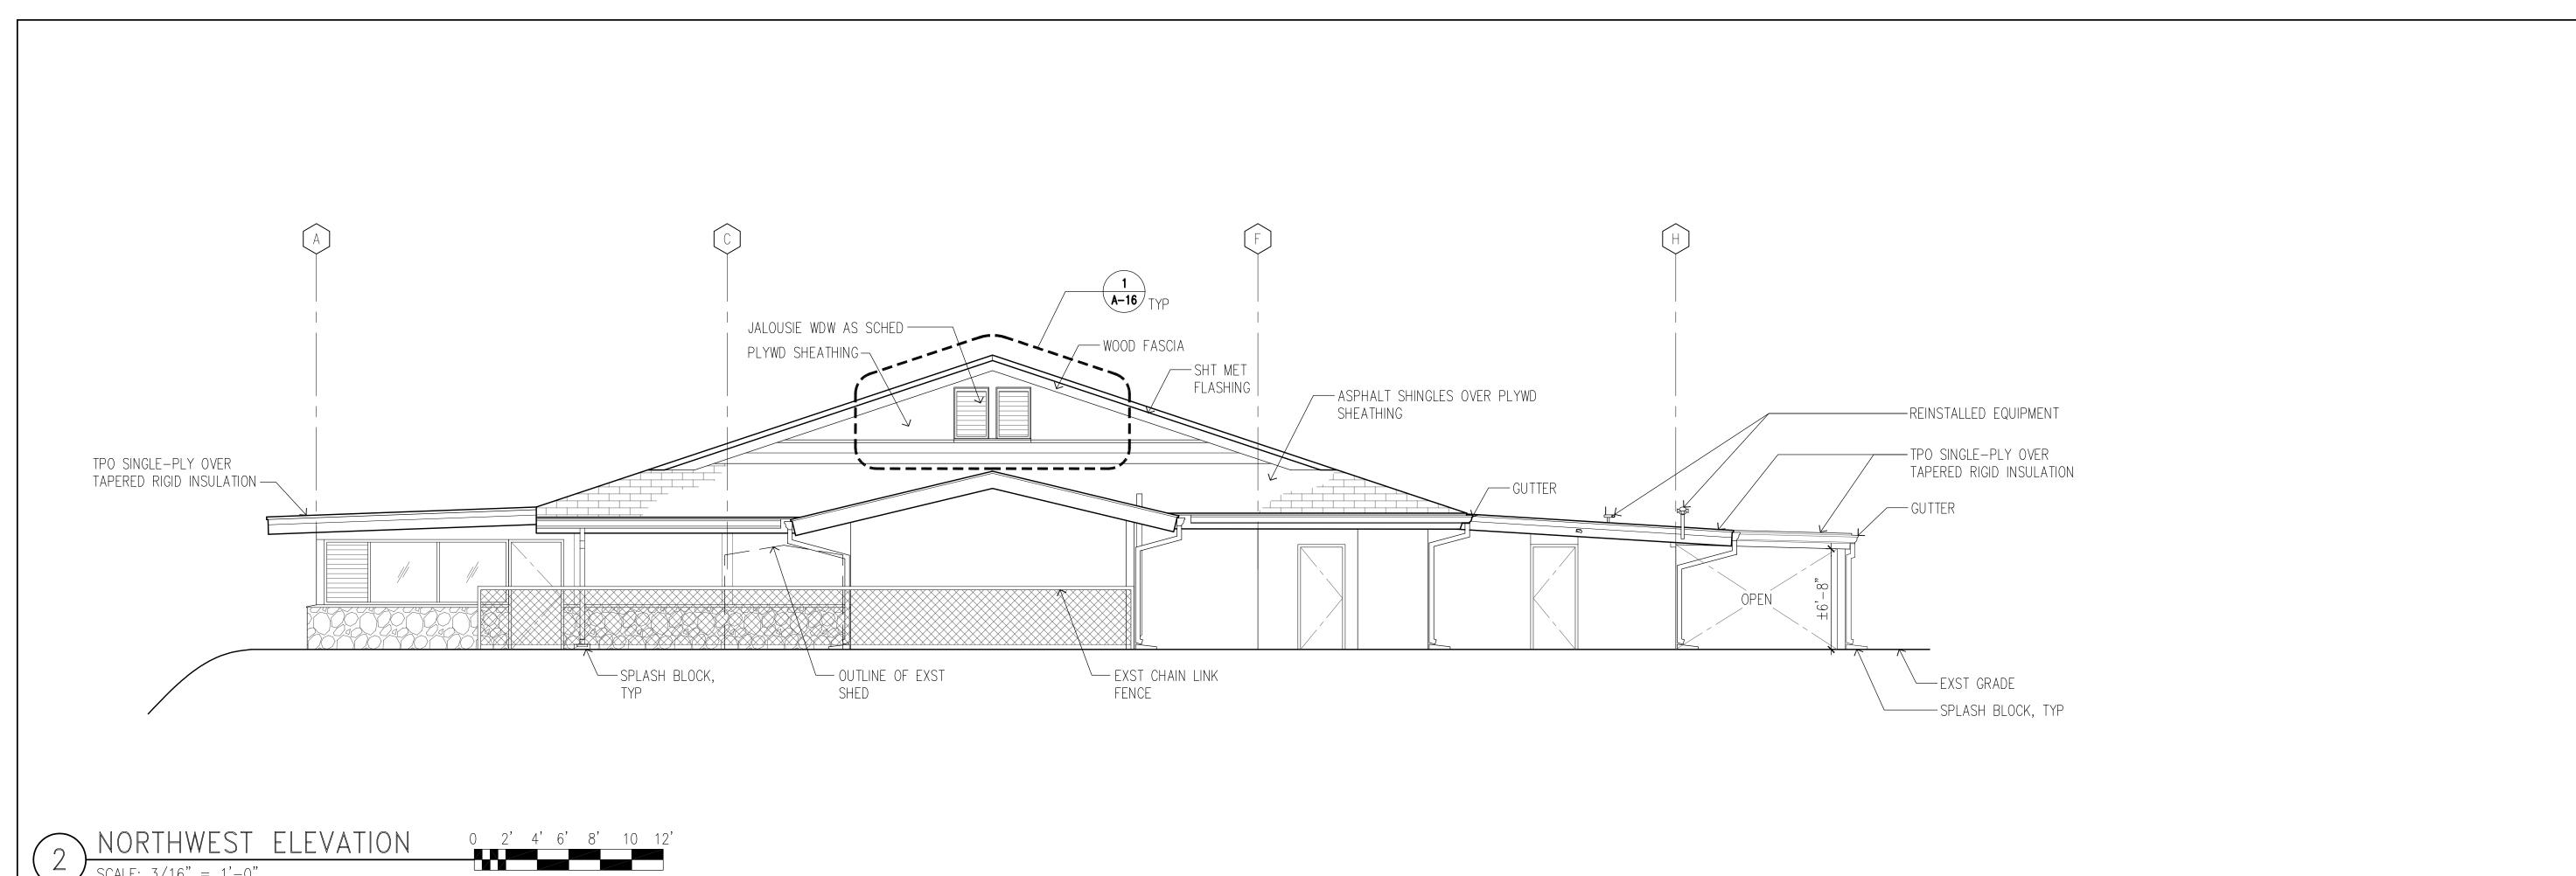
Carty Chang E-signed 2016-08-17 03:03PM HST carty.s.chang@hawaii.gov CHIEF ENGINEER







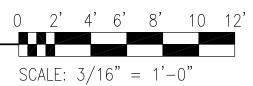



AND LANDSCAPE ARCHITECTS).



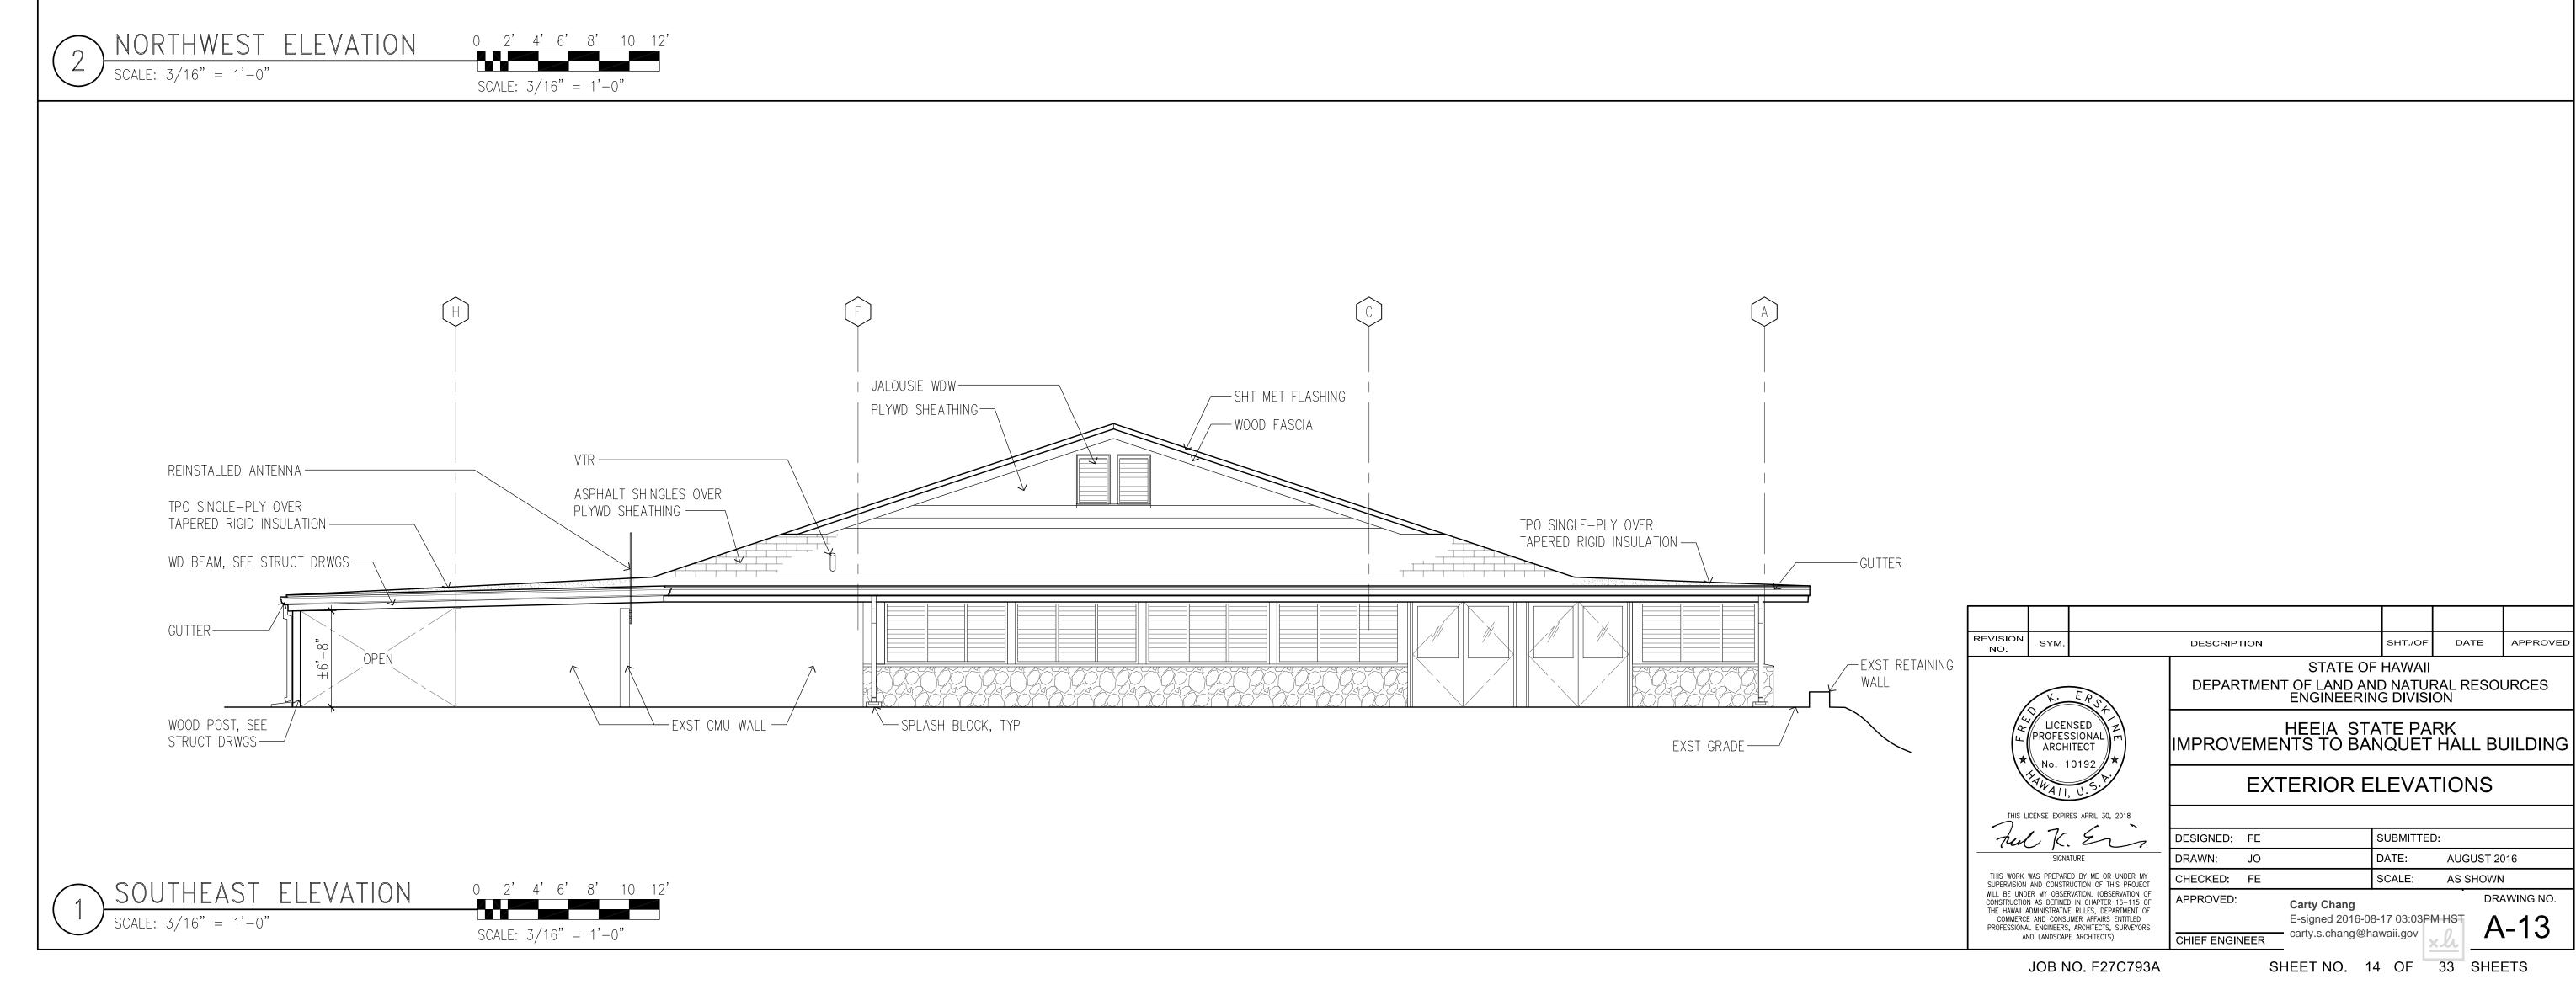

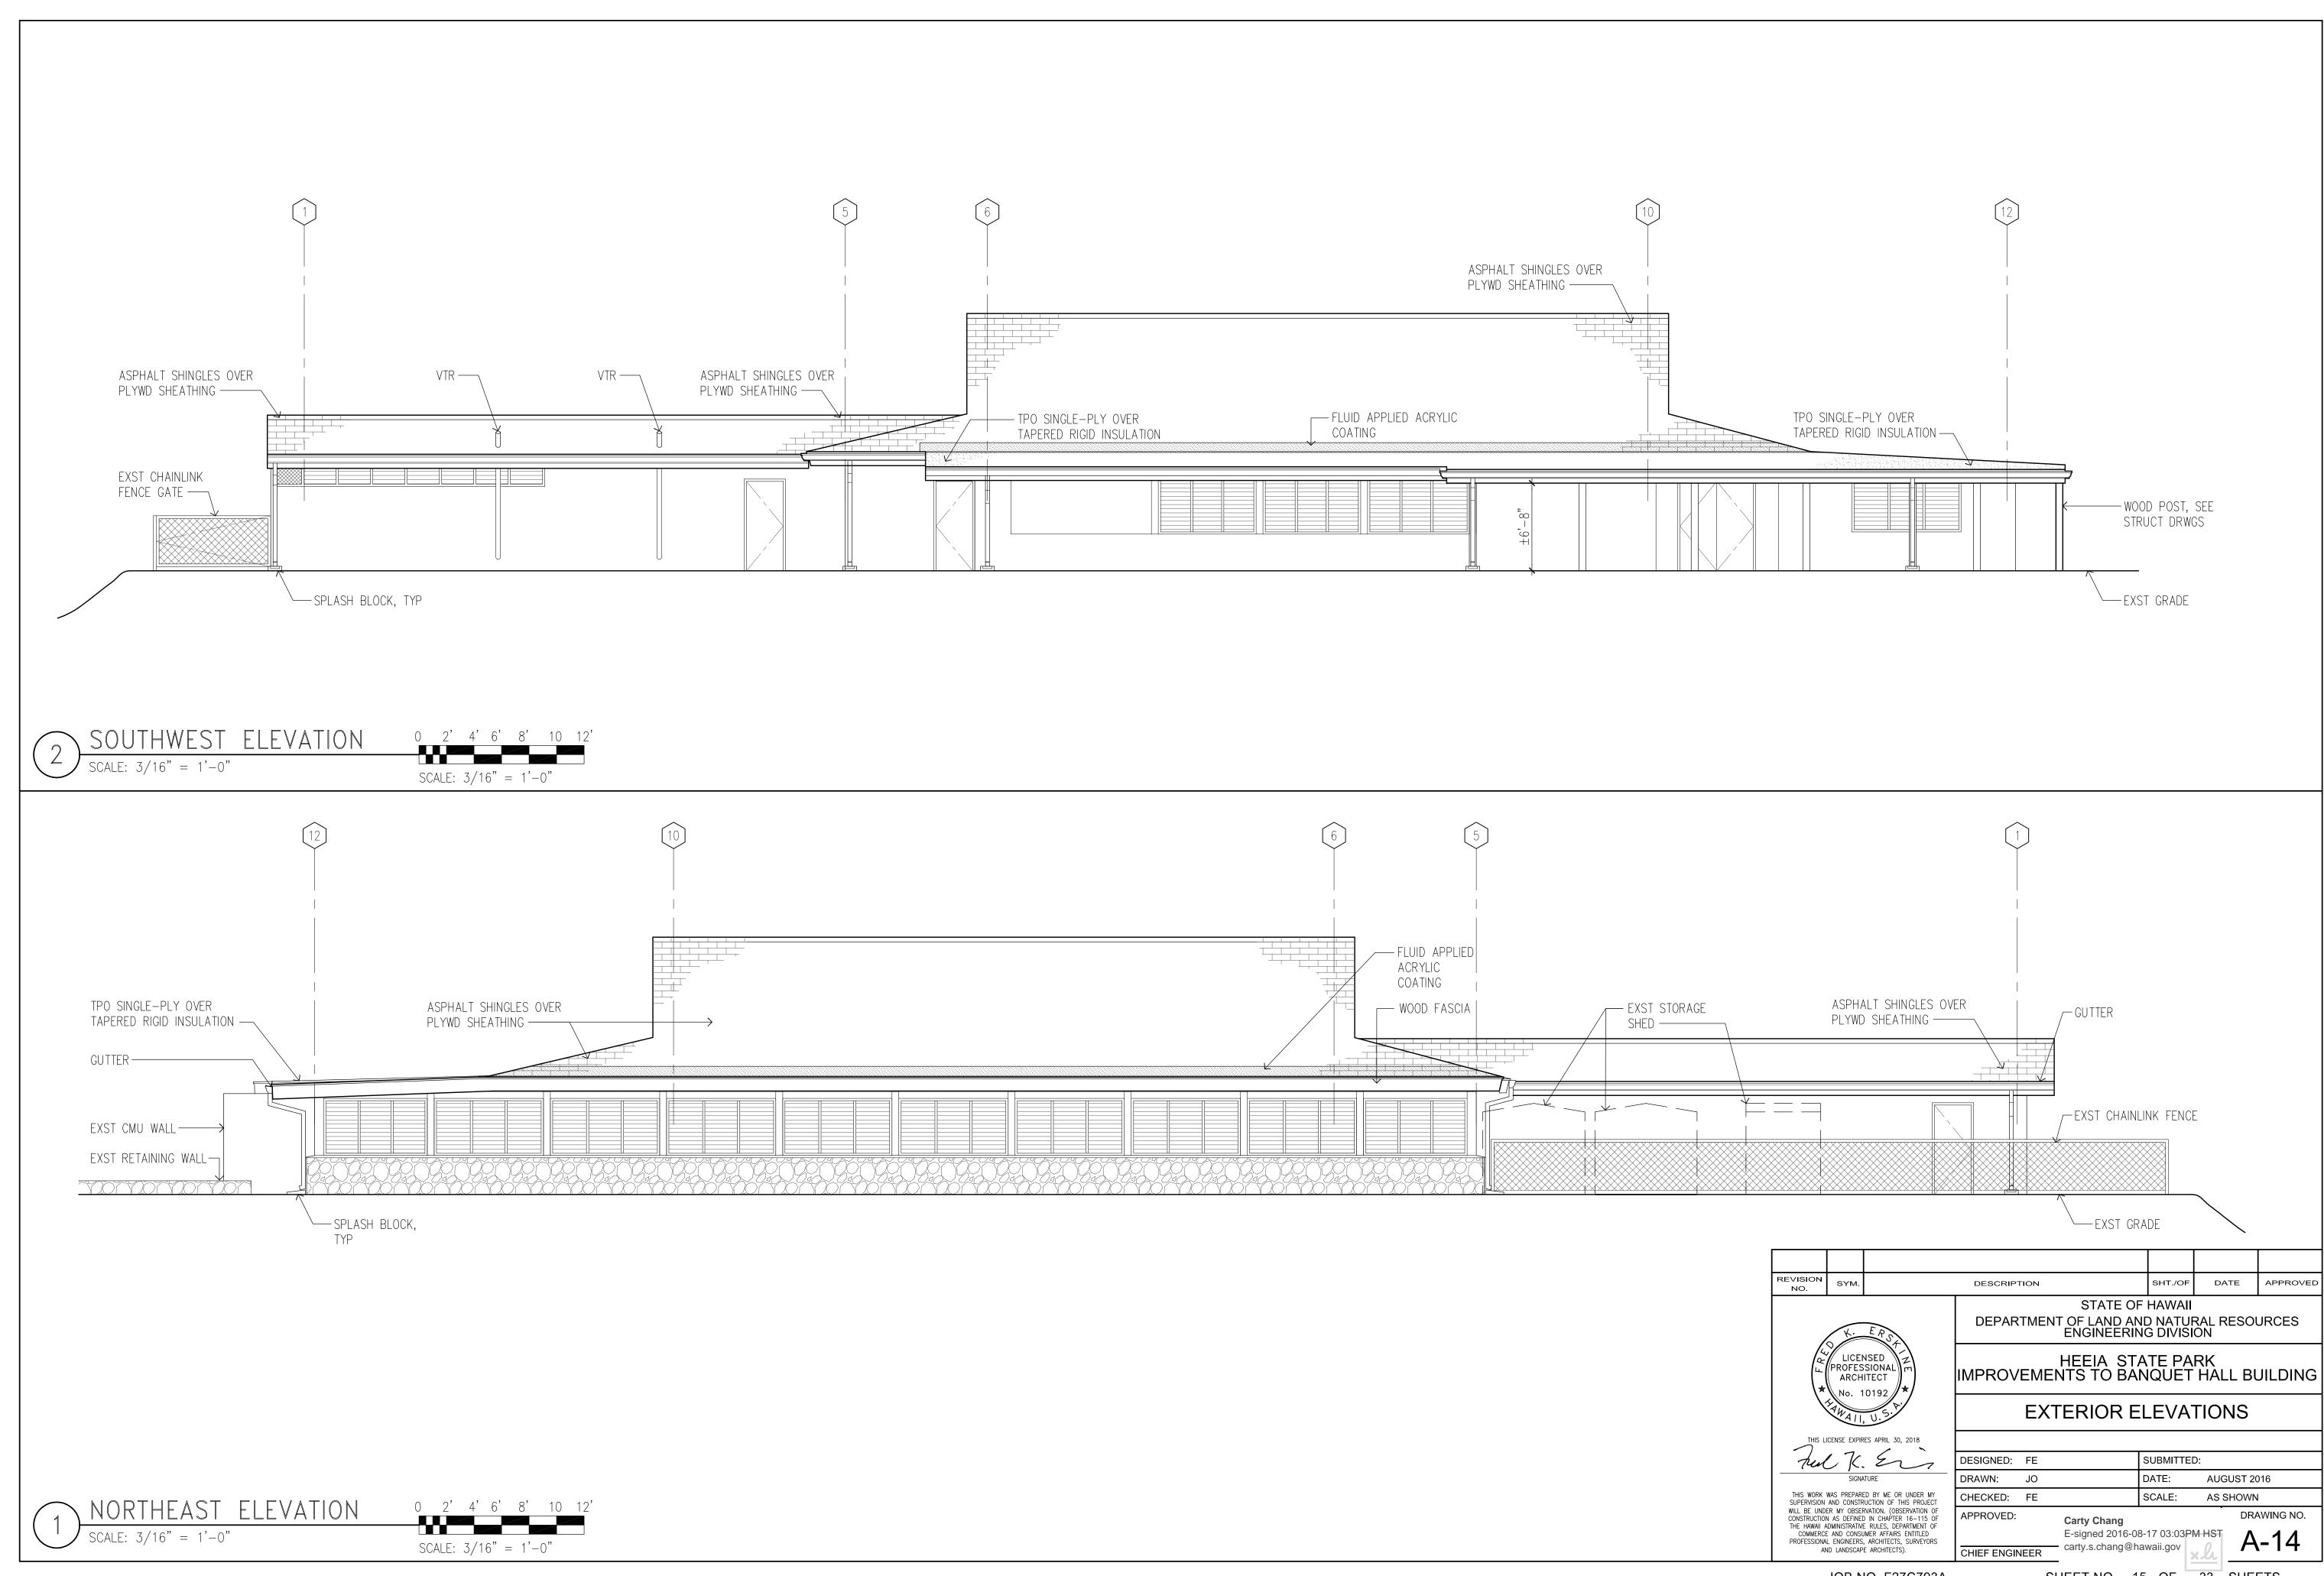


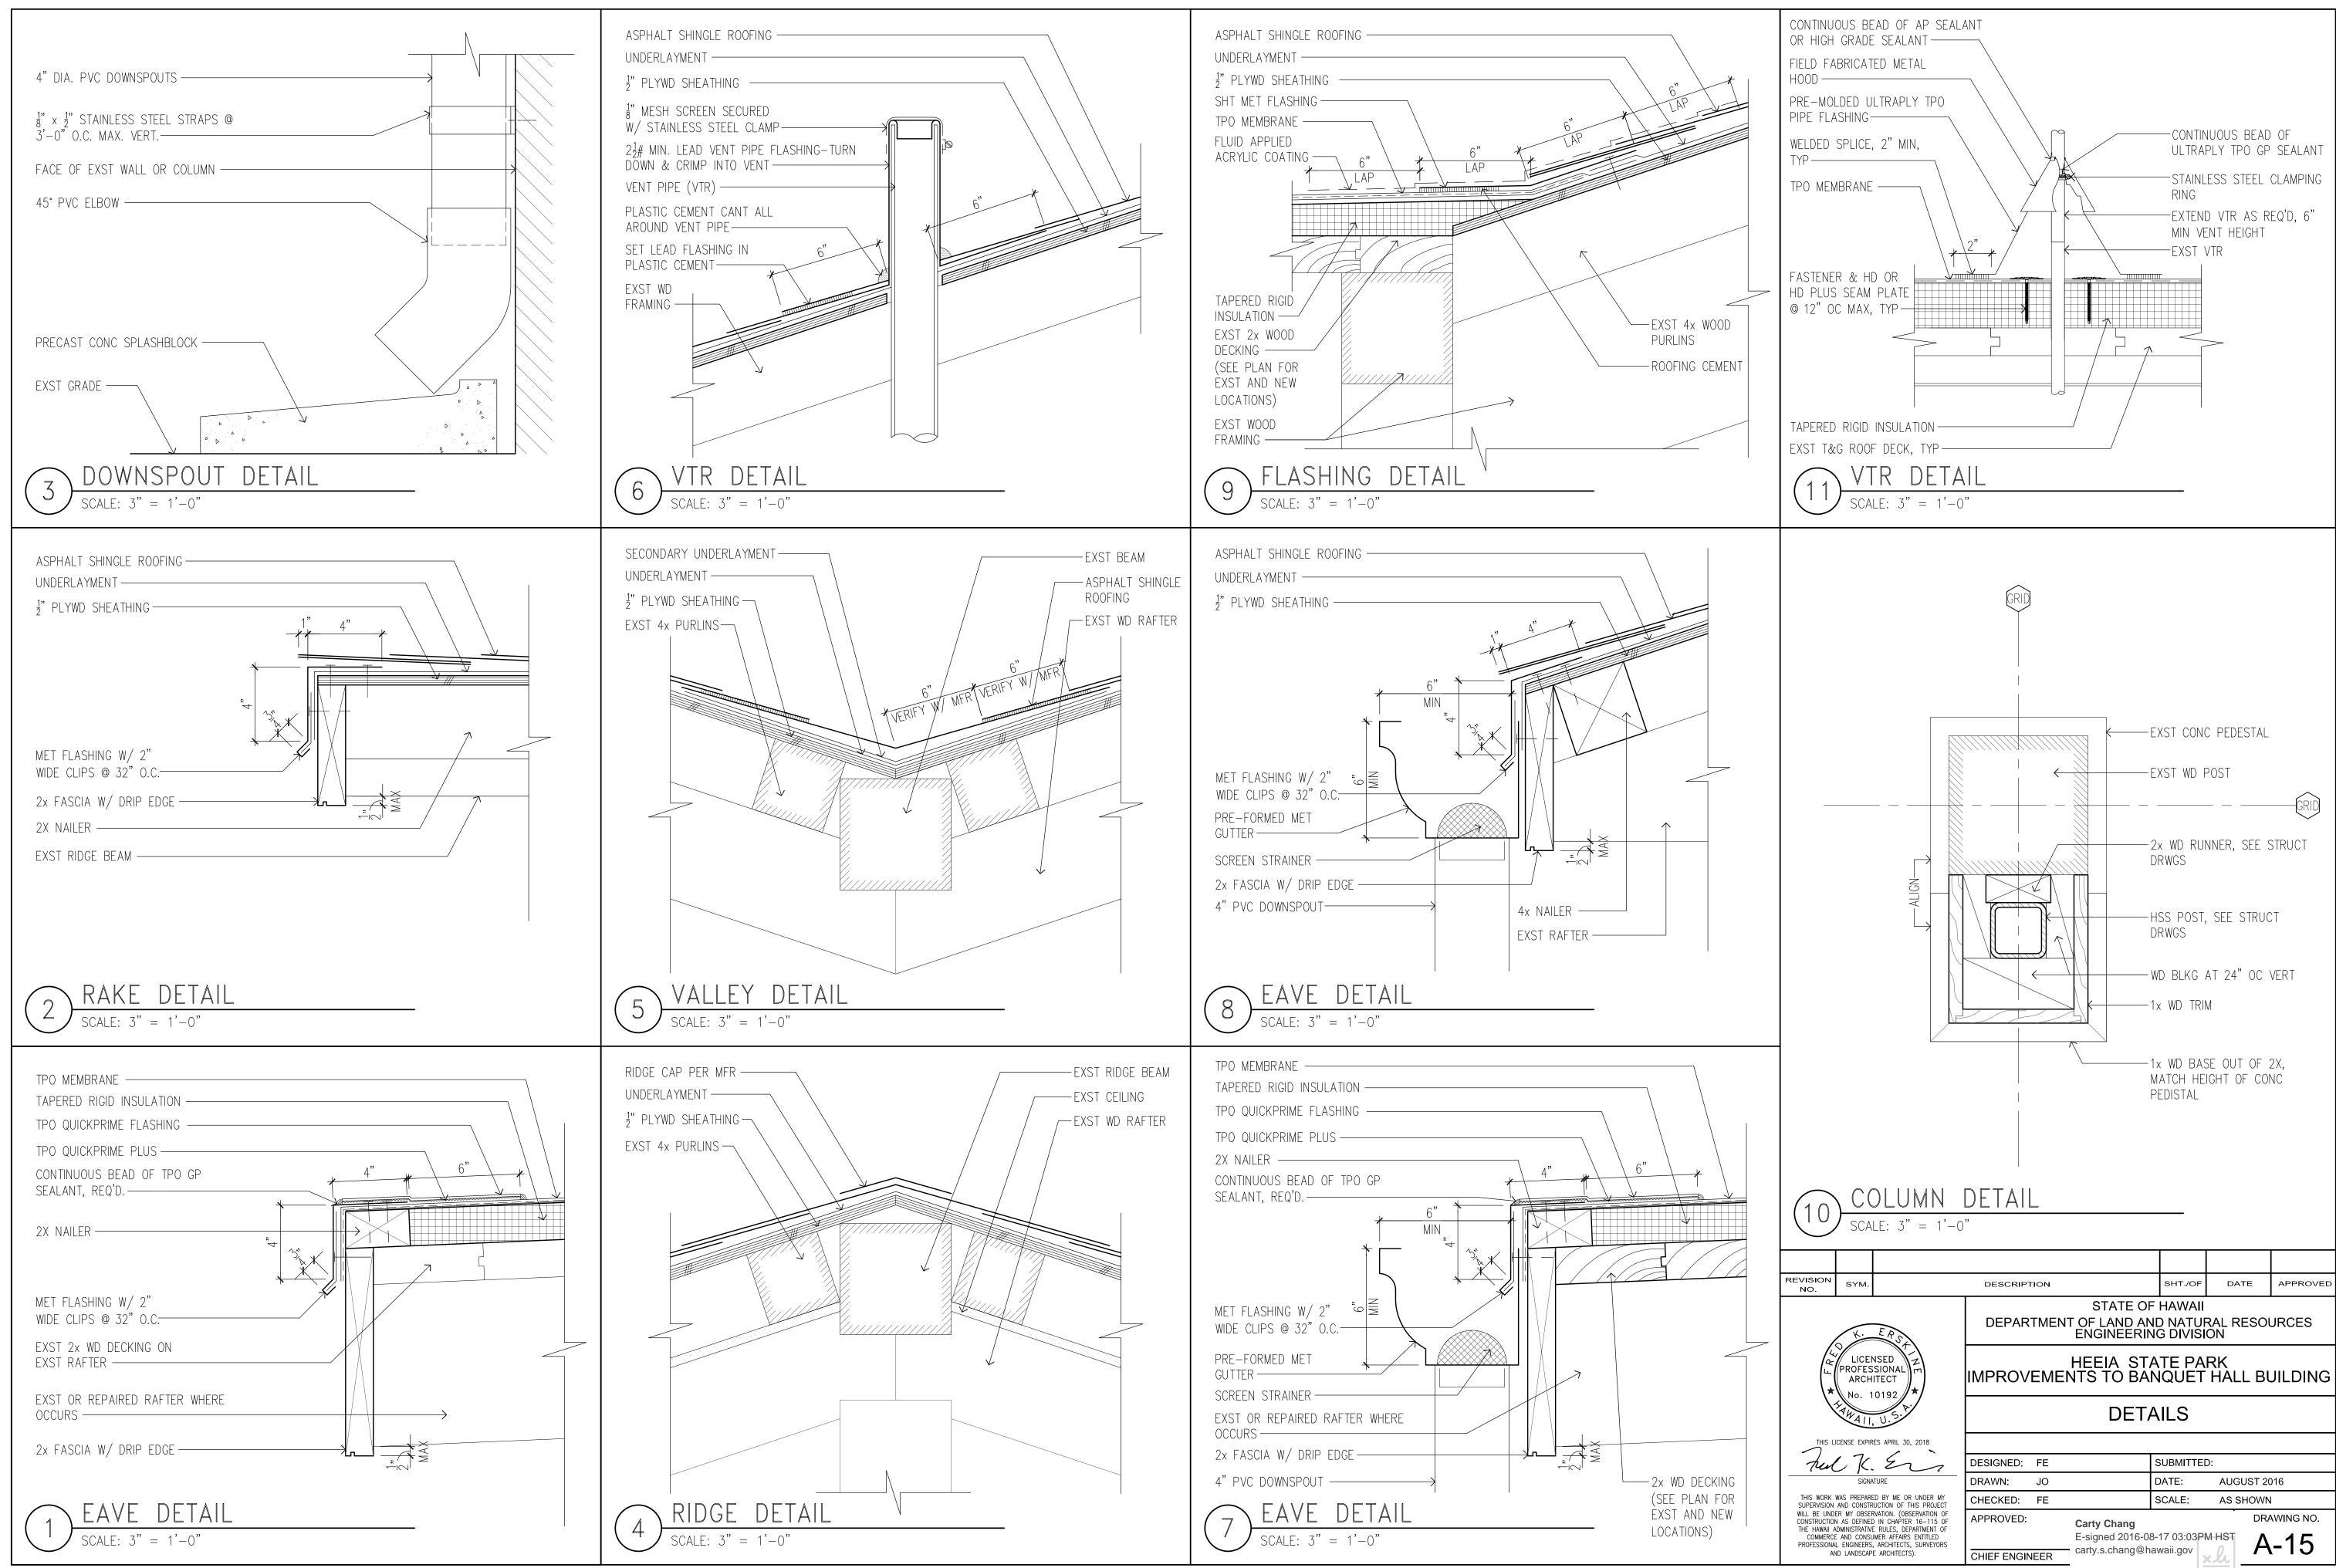


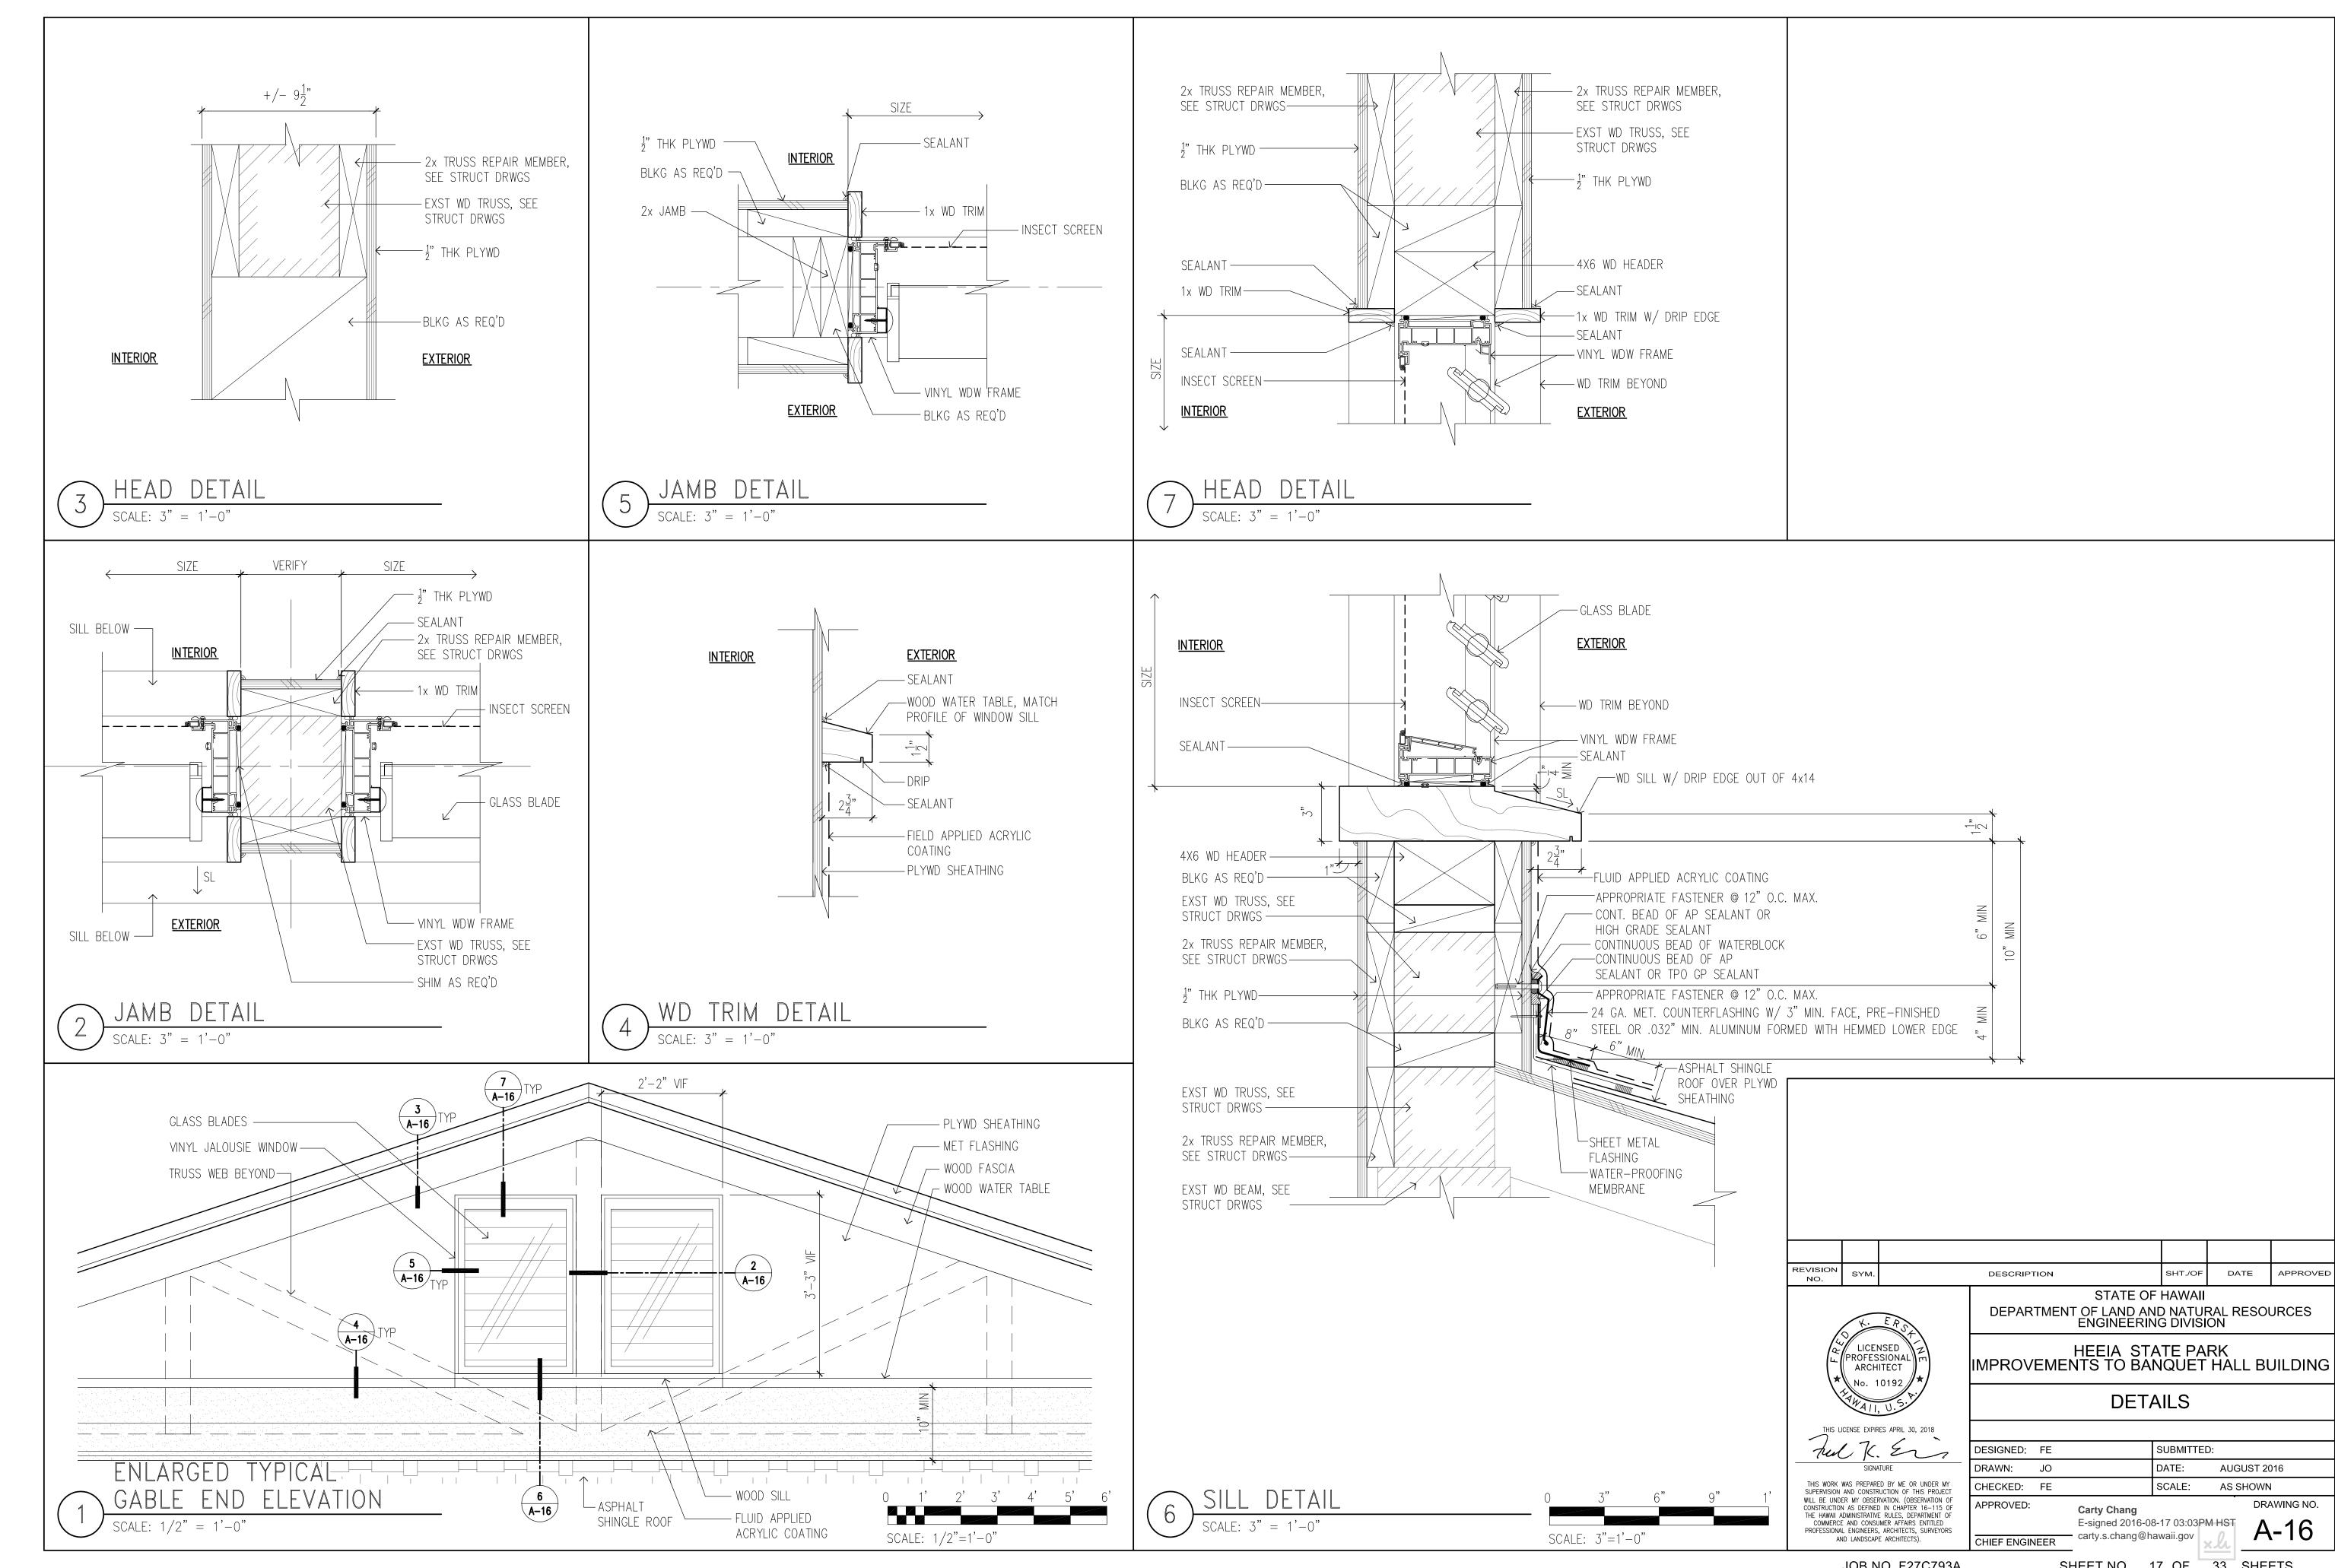

JOB NO. F27C793A

SHEET NO. 17 OF 33 SHEETS

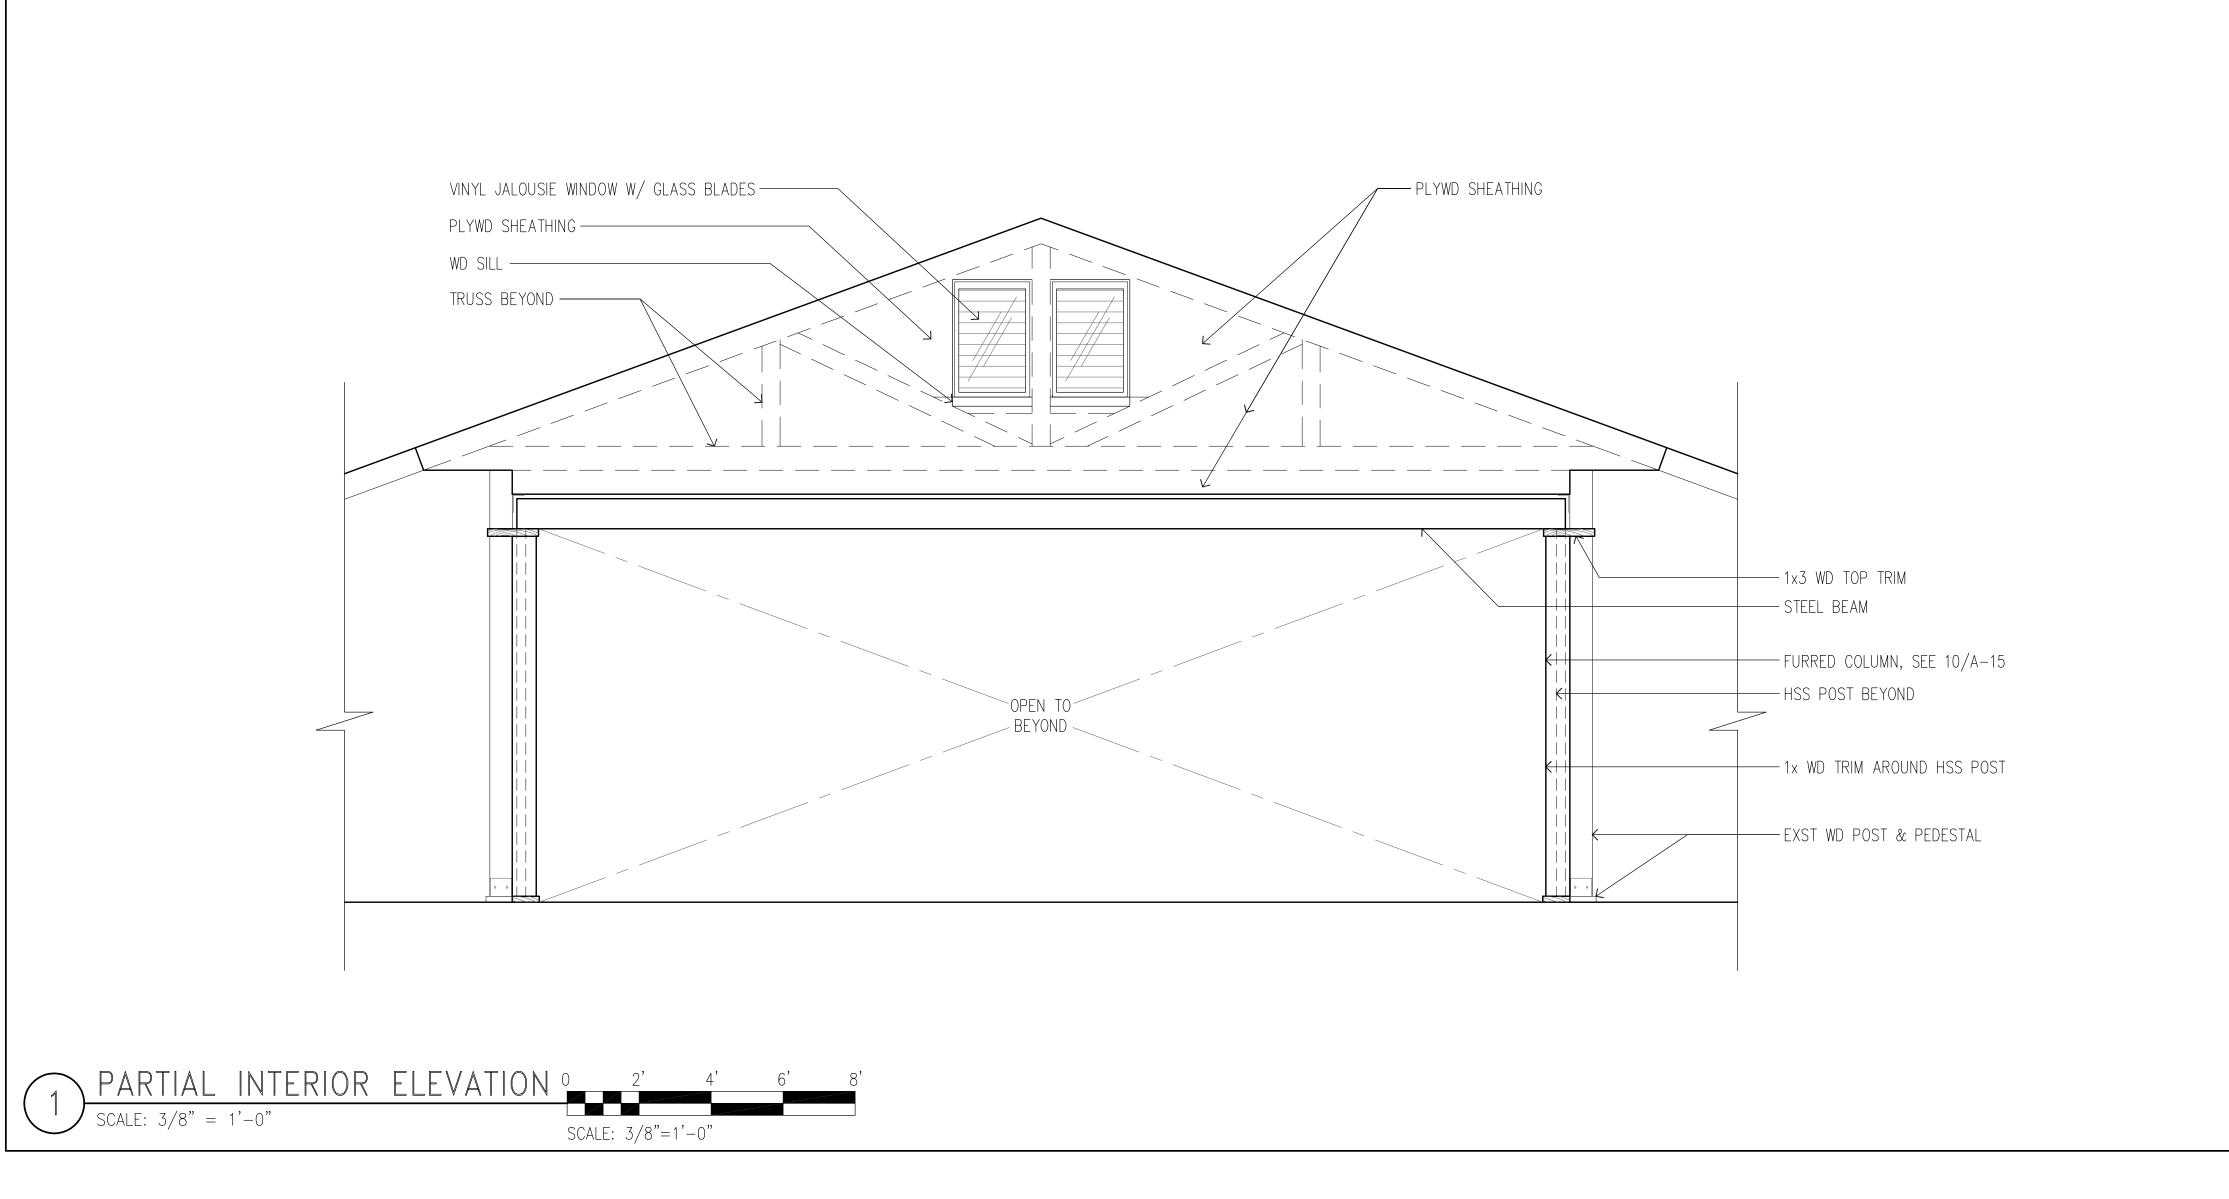

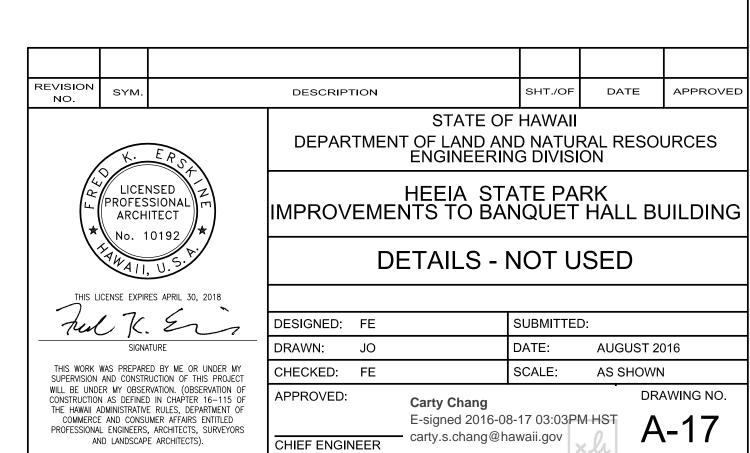

GENERAL:

- A. WORKMANSHIP AND MATERIALS SHALL CONFORM TO THE STATE BUILDING CODE OF HAWAII (IBC, 2006 EDITION AS AMENDED BY THE CITY AND COUNTY OF HONOLULU). HOWEVER, WHERE REFERENCE IS MADE TO PERFORMANCE CONFORMING TO OTHER STANDARDS THE MORE STRINGENT SHALL APPLY.
- B. THE CONTRACTOR SHALL COMPARE ALL THE CONTRACT DOCUMENTS WITH EACH OTHER AND REPORT IN WRITING TO THE ENGINEER ALL INCONSISTENCIES AND OMISSIONS.
- C. THE CONTRACTOR SHALL TAKE FIELD MEASUREMENTS AND VERIFY FIELD CONDITIONS AND SHALL COMPARE SUCH FIELD MEASUREMENTS AND CONDITIONS WITH THE DRAWINGS BEFORE COMMENCING WORK. REPORT IN WRITING TO THE ENGINEER ALL INCONSISTENCIES AND OMISSIONS.
- D. THE CONTRACTOR SHALL BE RESPONSIBLE FOR METHODS OF CONSTRUCTION, WORKMANSHIP AND JOB SAFETY. THE CONTRACTOR SHALL PROVIDE TEMPORARY SHORING AND BRACING AS REQUIRED FOR STABILITY OF STRUCTURAL MEMBERS AND SYSTEMS.
- E. CONSTRUCTION LOADING SHALL NOT EXCEED DESIGN LIVE LOAD UNLESS SPECIAL SHORING IS PROVIDED. ALLOWABLE LOADS SHALL BE REDUCED IN AREAS WHERE THE STRUCTURE HAS NOT ATTAINED FULL DESIGN STRENGTH.
- F. THE CONTRACTOR SHALL BE RESPONSIBLE FOR PROTECTION OF THE ADJACENT PROPERTIES, STRUCTURES, STREETS AND UTILITIES DURING THE CONSTRUCTION PERIOD.
- G. DETAILS NOTED AS TYPICAL ON THE STRUCTURAL DRAWINGS SHALL APPLY IN ALL CONDITIONS UNLESS SPECIFICALLY SHOWN OR NOTED.
- H. THE GENERAL CONTRACTOR AND HIS SUBCONTRACTORS MUST SUBMIT IN WRITING ANY REQUESTS FOR MODIFICATIONS TO THE PLANS AND SPECIFICATIONS.

DESIGN CRITERIA:

EPOXIED ANCHOR INSTALLATIONS:

- A. EPOXY USED FOR ANCHORING THREADED RODS AND REINFORCING STEEL INTO EXISTING CONCRETE OR FULLY GROUTED MASONRY SHALL BE HILTI HIT-HY 200 -A OR -R SYSTEM, SIMPSON SET-XP SYSTEM, OR APPROVED EQUAL, AND SHALL BE INSTALLED PER MANUFACTURER'S RECOMMENDATIONS.
- B. THE CONTRACTOR SHALL VERIFY THAT DRILLED ANCHORS ARE INSTALLED IN SOLID/FULLY GROUTED EXISTING MASONRY WALLS/CELLS. WHERE WALLS/CELLS ARE NOT FULLY GROUTED, THEY SHALL BE GROUTED WITH GROUT CONFORMING TO ASTM C476 HAVING A MINIMUM COMPRESSIVE STRENGTH OF 2,500 PSI AT 28 DAYS, TO PROVIDE A MINIMUM OF 8 INCHES ALL AROUND EACH ANCHOR INSTALLATION, UNLESS OTHERWISE NOTED.
- C. ANCHORS SHALL BE INSTALLED WITH THE MINIMUM EMBEDMENT REQUIREMENTS AS INDICATED ON THE DRAWINGS.

STRUCTURAL STEEL:

- A. FABRICATION AND ERECTION OF STRUCTURAL STEEL SHALL CONFORM TO THE AMERICAN INSTITUTE OF STEEL CONSTRUCTION MANUAL OF STEEL CONSTRUCTION, THIRTEENTH EDITION.
- B. STRUCTURAL STEEL SHALL CONFORM TO ASTM A36 UNLESS OTHERWISE NOTED.
- C. STEEL TUBES SHALL CONFORM TO ASTM A500. GRADE B
- D. BOLTS FOR STRUCTURAL STEEL TO STRUCTURAL STEEL CONNNECTIONS SHALL CONFORM TO ASTM A325, TYPE N. USE LOAD INDICATOR WASHERS.

STRUCTURAL STEEL (CONT'D):

- F. THREADED RODS SHALL CONFORM TO ASTM F1554 GRADE 36 UNLESS OTHERWISE NOTED.
- G. ANCHOR RODS FOR STRUCTURAL STEEL TO CONCRETE PEDESTAL OR FOOTING ANCHORAGE SHALL CONFORM TO ASTM F1554 GRADE 36 UNLESS OTHERWISE NOTED.
- H. WELDS AND WELDING PROCEDURES SHALL CONFORM TO THE STRUCTURAL WELDING CODE AWS D1.1 OF THE AMERICAN WELDING SOCIETY.
- I. WELDING SHALL BE PERFORMED BY WELDERS PREQUALIFIED FOR WELDING PROCEDURES TO BE USED.
- J. WELDING ELECTRODES SHALL BE E70XX.
- K. ALL STEEL SHALL BE PRIME PAINTED IN THE SHOP.
- L. EXPOSED STEEL SHALL BE HOT-DIPPED GALVANIZED.
- M. THE FOLLOWING SHALL BE SUBMITTED TO THE ENGINEER FOR REVIEW:
 - A. SHOP DRAWINGS DETAILING FABRICATION OF STRUCTURAL STEEL COMPONENTS INCLUDING DETAILS OF CUTS, CONNECTIONS, HOLES; WELDS; TYPE, SIZE AND LENGTH OF BOLTS; AND OTHER PERTINENT DATA.
 - B. CURRENT WELDER'S CERTIFICATION OF EACH INDIVIDUAL PERFORMING WELDING WORK.
 - C. MILL TEST REPORTS SIGNED BY MANUFACTURERS CERTIFYING THAT STRUCTURAL STEEL, BOLTS, AND OTHER COMPONENTS COMPLY WITH REQUIREMENTS.

STRUCTURAL LUMBER:

- A. STRUCTURAL LUMBER SHALL BE TERMITE AND ROT PRESSURE PRESERVATIVE TREATED COASTAL DOUGLAS FIR CONFORMING TO STANDARD GRADING AND DRESSING RULES OF THE WEST COAST LUMBER INSPECTION BUREAU (WCLIB).
- B. UNLESS OTHERWISE NOTED, STRUCTURAL MEMBERS SHALL HAVE THE FOLLOWING GRADES OR BETTER:
- A. 2X JOISTS AND RAFTERS——GRADE NO. 2
- B. 4X BEAMS AND HEADERS——GRADE NO. 1
- C. 6X POSTS GRADE NO. 1 AND BETTER
- C. SHEATHING SHALL BE IDENTIFIED WITH THE APPROPRIATE TRADEMARK OF THE AMERICAN PLYWOOD ASSOCIATION, AND SHALL MEET THE REQUIREMENTS OF THE LATEST EDITION OF U.S. PRODUCT STANDARD PS 1 OR APA'S PERFORMANCE STANDARDS.


 A. ROOF SHEATHING SHALL BE TONGUE AND GROOVE CDX APA RATED SHEATHING, EXPOSURE 1, 32/16 SPAN RATING.
- D. 2X ROOF DECKING SHALL BE SELECTED DECKING GRADE.
- E. PROVIDE MINIMUM NAILING PER TABLE 2304.9.1 OF THE INTERNATIONAL BUILDING CODE, UNLESS OTHERWISE NOTED.
- F. ALL NAILS SHALL BE GALVANIZED COMMON NAILS. ALL NAILS IN EXPOSED, EXTERIOR CONNECTIONS SHALL BE HOT DIPPED GALVANIZED.
- G. BOLTS SHALL CONFORM TO ASTM A307, AND SHALL BE GALVANIZED.
- H. PREFABRICATED FRAMING HARDWARE SHALL BE GALVANIZED SIMPSON STRONG TIE HARDWARE, MINIMUM G90 COATING, OR APPROVED EQUAL. INSTALL IN ACCORDANCE WITH MANUFACTURER'S RECOMMENDATIONS.
- I. PLACE A LAYER OF 30# ROOFING FELT BETWEEN ALL WOOD MEMBERS AND CONCRETE OR MASONRY SURFACES.

SPECIAL INSPECTION:


- A. CONTRACTOR SHALL BE RESPONSIBLE FOR ENSURING THAT SPECIAL INSPECTION OF PORTIONS OF THE WORK, AS REQUIRED BY THE BUILDING CODE OF THE CITY AND COUNTY OF HONOLULU, IS MADE AT THE APPROPRIATE TIME. THE CONTRACTOR SHALL GIVE TIMELY NOTICE OF WHEN AND WHERE INSPECTIONS ARE TO BE MADE AND PROVIDE ACCESS FOR THE INSPECTOR. THE CONTRACTOR SHALL CORRECT DEFECTIVE WORK AT NO ADDITIONAL COST TO THE OWNER AND PAY FOR RE-INSPECTION.
- B. THE FOLLOWING STRUCTURAL WORK REQUIRES SPECIAL INSPECTION:
 - A. DRILLED AND EPOXIED THREADED RODS IN CONCRETE OR MASONRY
 - B. STRUCTURAL WELDING
 - C. HIGH STRENGTH BOLTING
- THE SPECIAL INSPECTOR SHALL FURNISH INSPECTION REPORTS TO THE OWNER, LICENSED ENGINEER OR ARCHITECT OF RECORD AND OTHER OWNER-DESIGNATED PERSONS. REPORTS SHALL INDICATE THAT WORK INSPECTED WAS DONE IN CONFORMANCE TO APPROVED CONSTRUCTION DOCUMENTS. THE SPECIAL INSPECTOR SHALL SUBMIT A FINAL SIGNED REPORT TO THE OWNER AND LICENSED ENGINEER OR ARCHITECT OF RECORD STATING WHETHER THE WORK REQUIRING SPECIAL INSPECTION WAS, TO THE BEST OF THE INSPECTOR'S KNOWLEDGE, IN CONFORMANCE TO THE APPROVED PLANS AND SPECIFICATIONS AND THE APPLICABLE WORKMANSHIP PROVISIONS OF THIS CODE PRIOR TO THE FINAL INSPECTION REQUIRED UNDER THE BUILDING CODE SECTION 109.3.10 THE LICENSED ENGINEER OR ARCHITECT OF RECORD SHALL SUBMIT A WRITTEN STATEMENT VERIFYING RECEIPT OF THE FINAL INSPECTION REPORTS AND DOCUMENTING THAT THERE ARE NO UNRESOLVED CODE REQUIREMENTS THAT CREATE SIGNIFICANT PUBLIC SAFETY DEFICIENCIES.
- D. CONTRACTOR SHALL SUBMIT A STATEMENT CONTAINING AN ACKNOWLEDGEMENT OF AWARENESS OF THE SPECIAL INSPECTION REQUIREMENTS CONTAINED ON THE DRAWINGS AND THAT THE CONSTRUCTION REQUIRING SPECIAL INSPECTIONS WILL BE MADE ACCESSIBLE FOR INSPECTIONS.


VARIABLE QUANTITIES:


- A. THIS PROJECT INCORPORATES VARIABLE QUANTITES TO ACCOUNT FOR THE CONSTRUCTION COSTS OF UNSEEN EXISTING DAMAGES THAT ARE ENCOUNTERED DURING CONSTRUCTION THAT MUST BE REMOVED AND/OR REPAIRED UNDER THE SCOPE OF WORK. REFER TO SPECIFICATION SECTION 01270 VARIABLE QUANTITIES UNIT PRICES.
- B. THE FOLLOWING ARE THE QUALIFYING VARIABLE QUANTITY ITEMS FOR THIS PROJECT:
 - A. REMOVE DAMAGED EXISTING 2X ROOF DECKING AND INSTALL NEW 2X ROOF DECKING
 - B. REMOVE DAMAGED EXISTING 2X PURLINS AND INSTALL NEW 2X PURLINS OVER KITCHEN AREA
 - C. REMOVE DAMAGED EXISTING 4X ROOF PURLINS AND INSTALL NEW 4X PURLINS OVER BANQUET HALL AREA

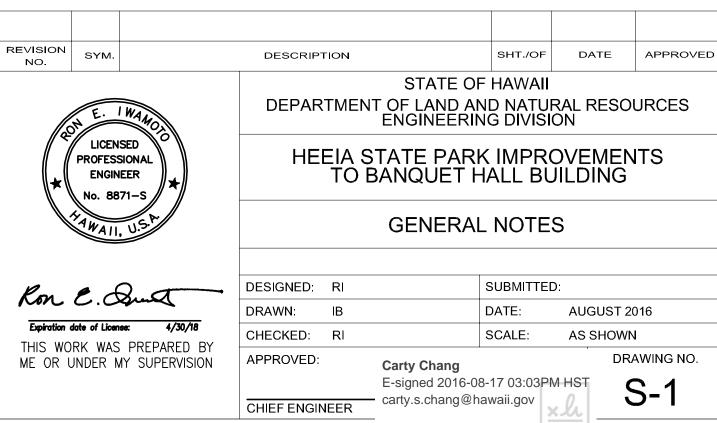




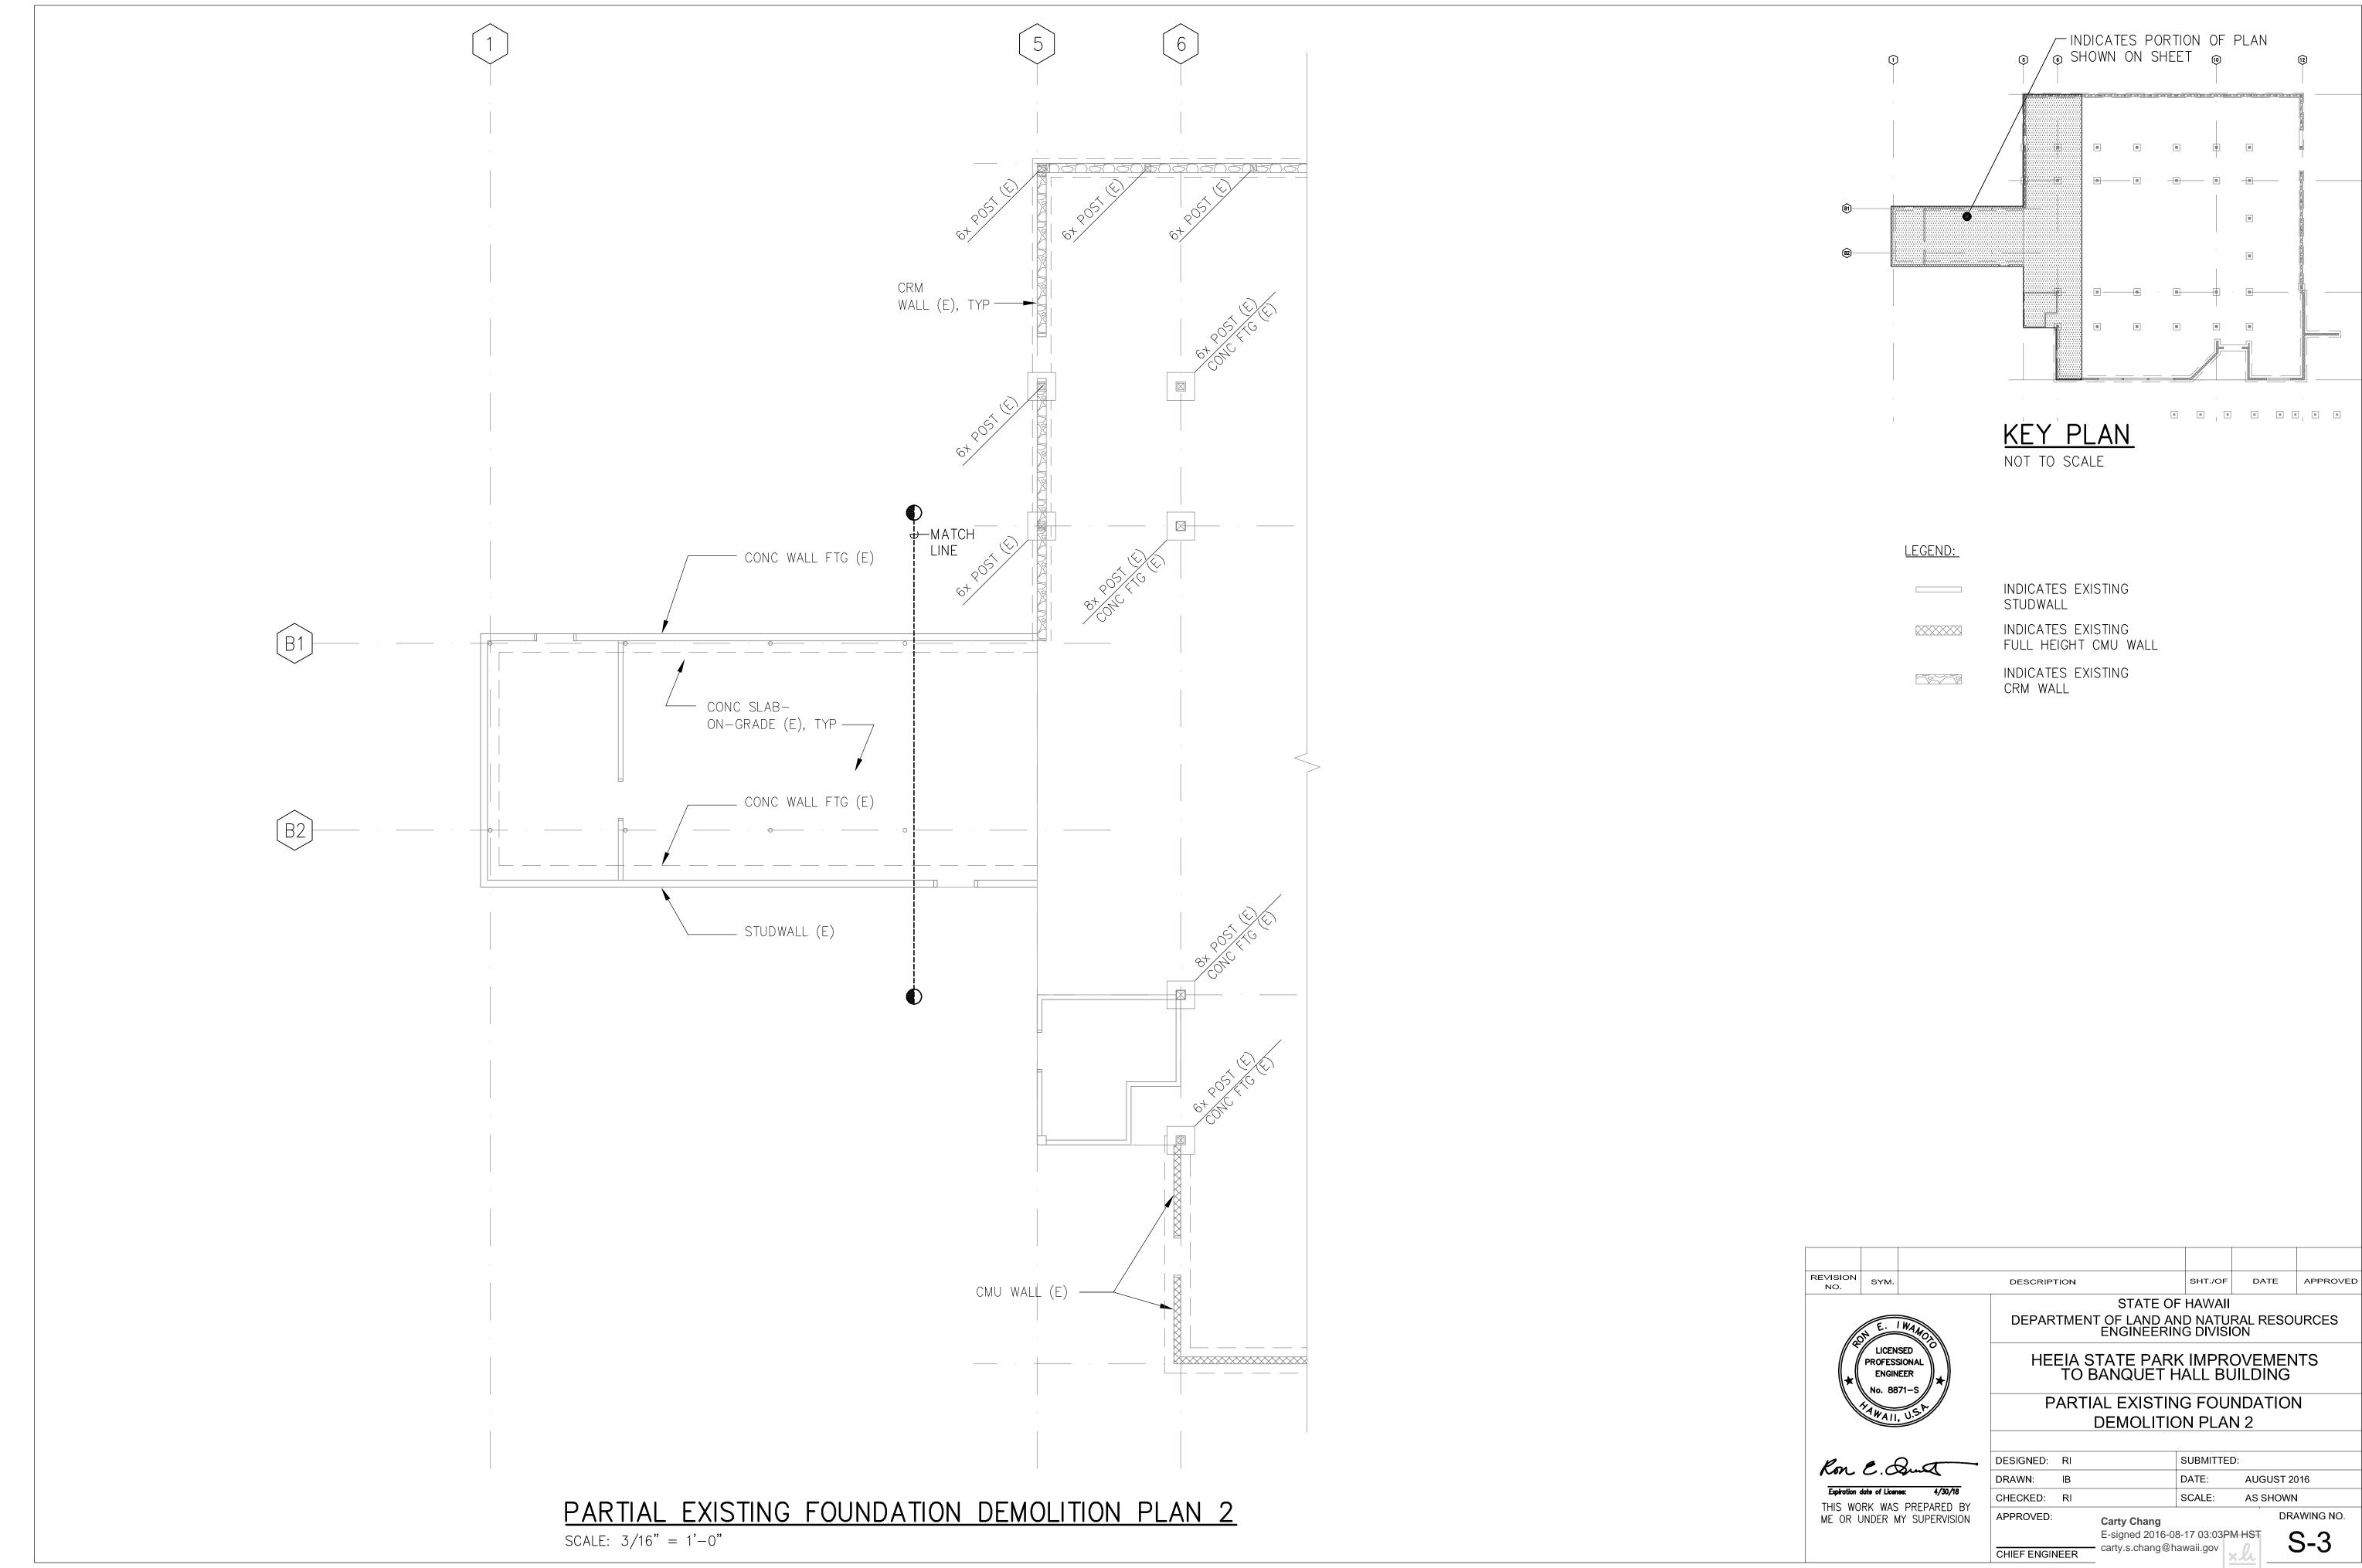

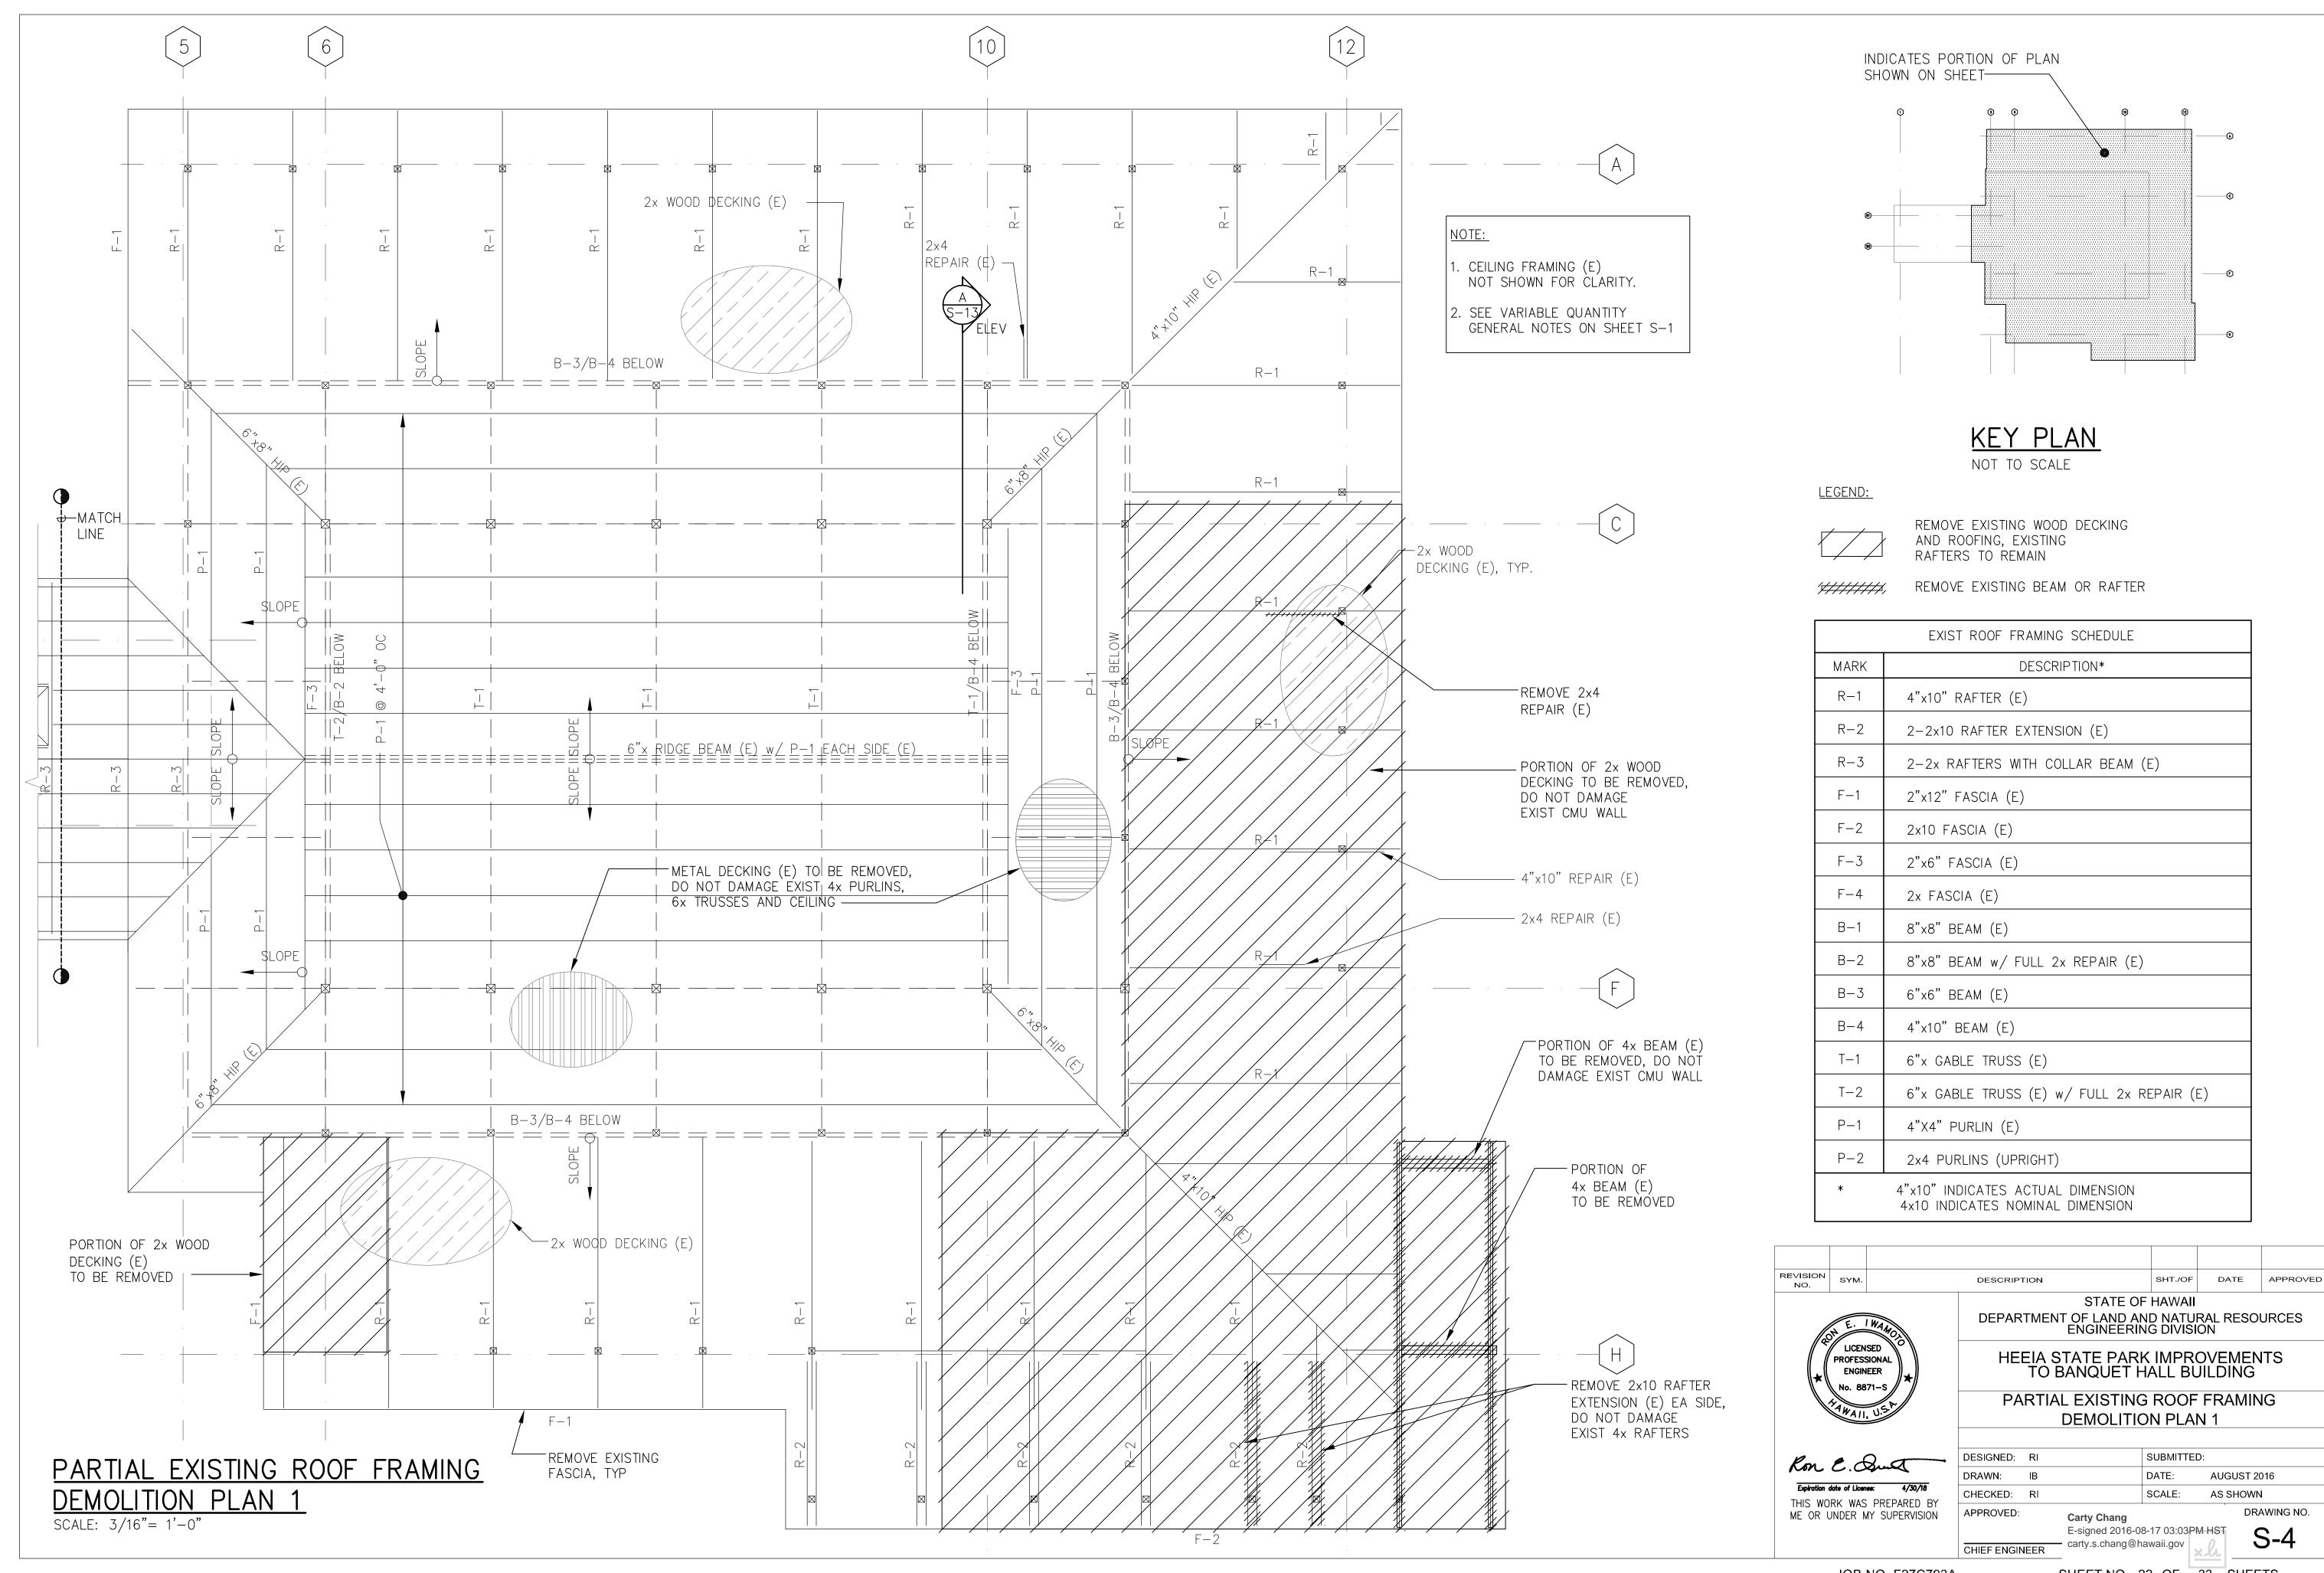

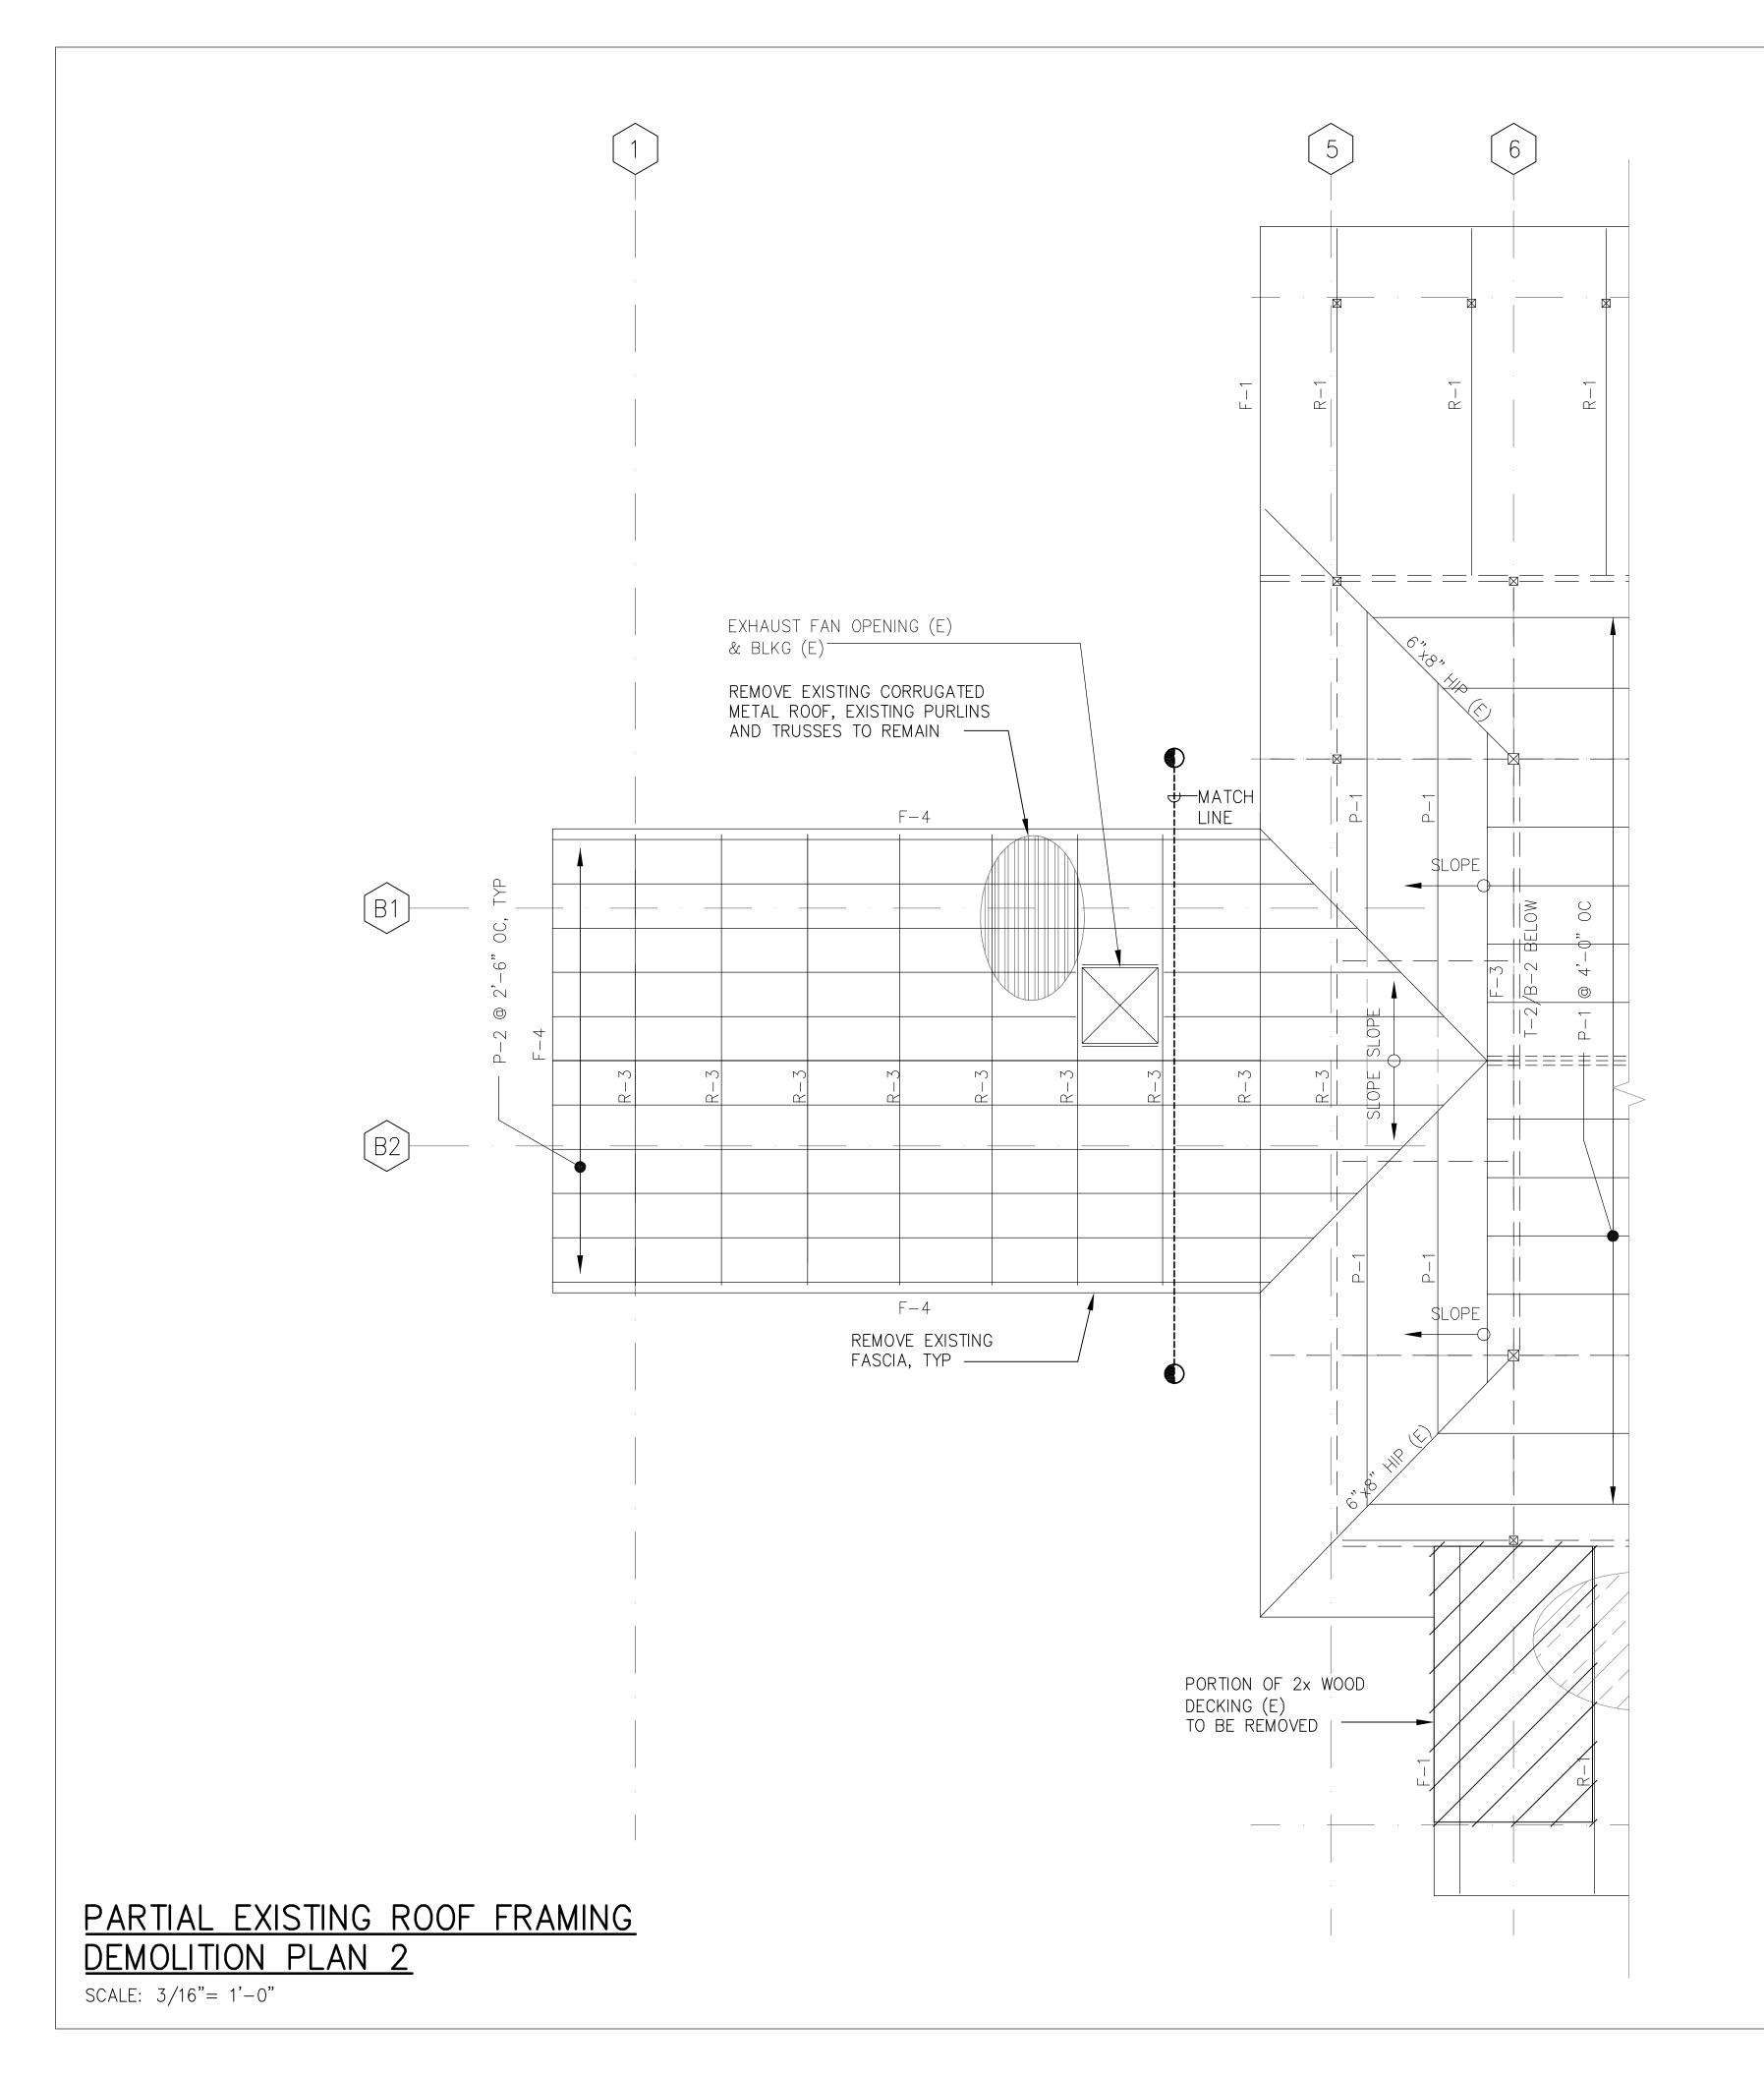

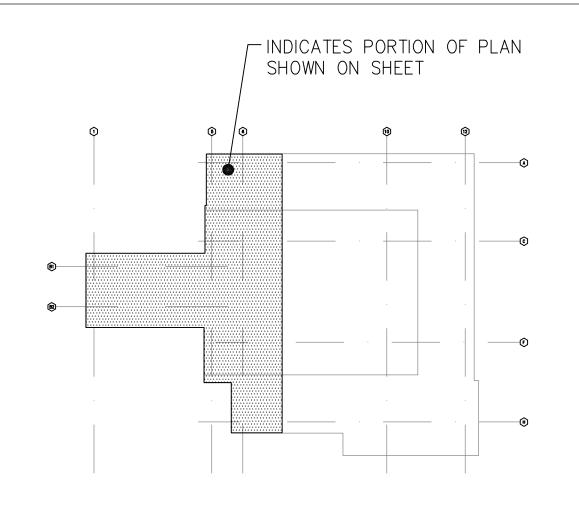

KEY PLAN

NOT TO SCALE

LEGEND:


REMOVE EXISTING WOOD DECKING AND ROOFING, EXISTING RAFTERS TO REMAIN


194444444, REMOVE EXISTING BEAM OR RAFTER


	EXIST ROOF FRAMING SCHEDULE		
MARK	DESCRIPTION*		
R-1	4"x10" RAFTER (E)		
R-2	2-2x10 RAFTER EXTENSION (E)		
R-3	2-2x RAFTERS WITH COLLAR BEAM (E)		
F-1	2"x12" FASCIA (E)		
F-2	2x10 FASCIA (E)		
F-3	2"x6" FASCIA (E)		
F-4	2x FASCIA (E)		
B-1	8"x8" BEAM (E)		
B-2	8"x8" BEAM w/ FULL 2x REPAIR (E)		
B-3	6"x6" BEAM (E)		
B-4	4"x10" BEAM (E)		
T-1	6"x GABLE TRUSS (E)		
T-2	6"x GABLE TRUSS (E) w/ FULL 2x REPAIR (E)		
P-1	4"X4" PURLIN (E)		
P-2	2x4 PURLINS (UPRIGHT)		
*	4"x10" INDICATES ACTUAL DIMENSION 4x10 INDICATES NOMINAL DIMENSION		


NOTE:


- . CEILING FRAMING (E) NOT SHOWN FOR CLARITY.
- 2. SEE VARIABLE QUANTITY
 GENERAL NOTES ON SHEET S-1

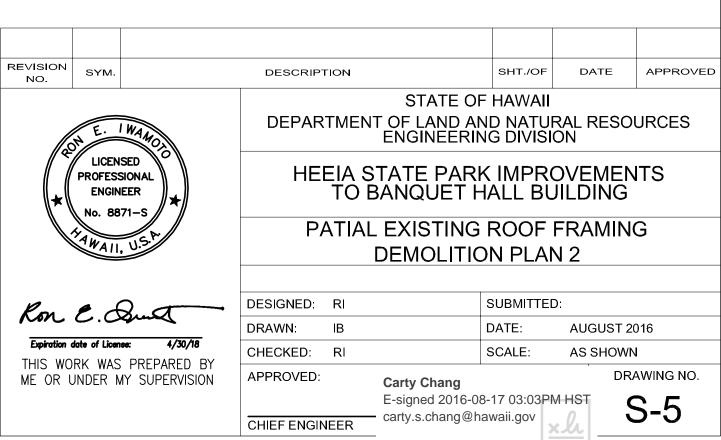

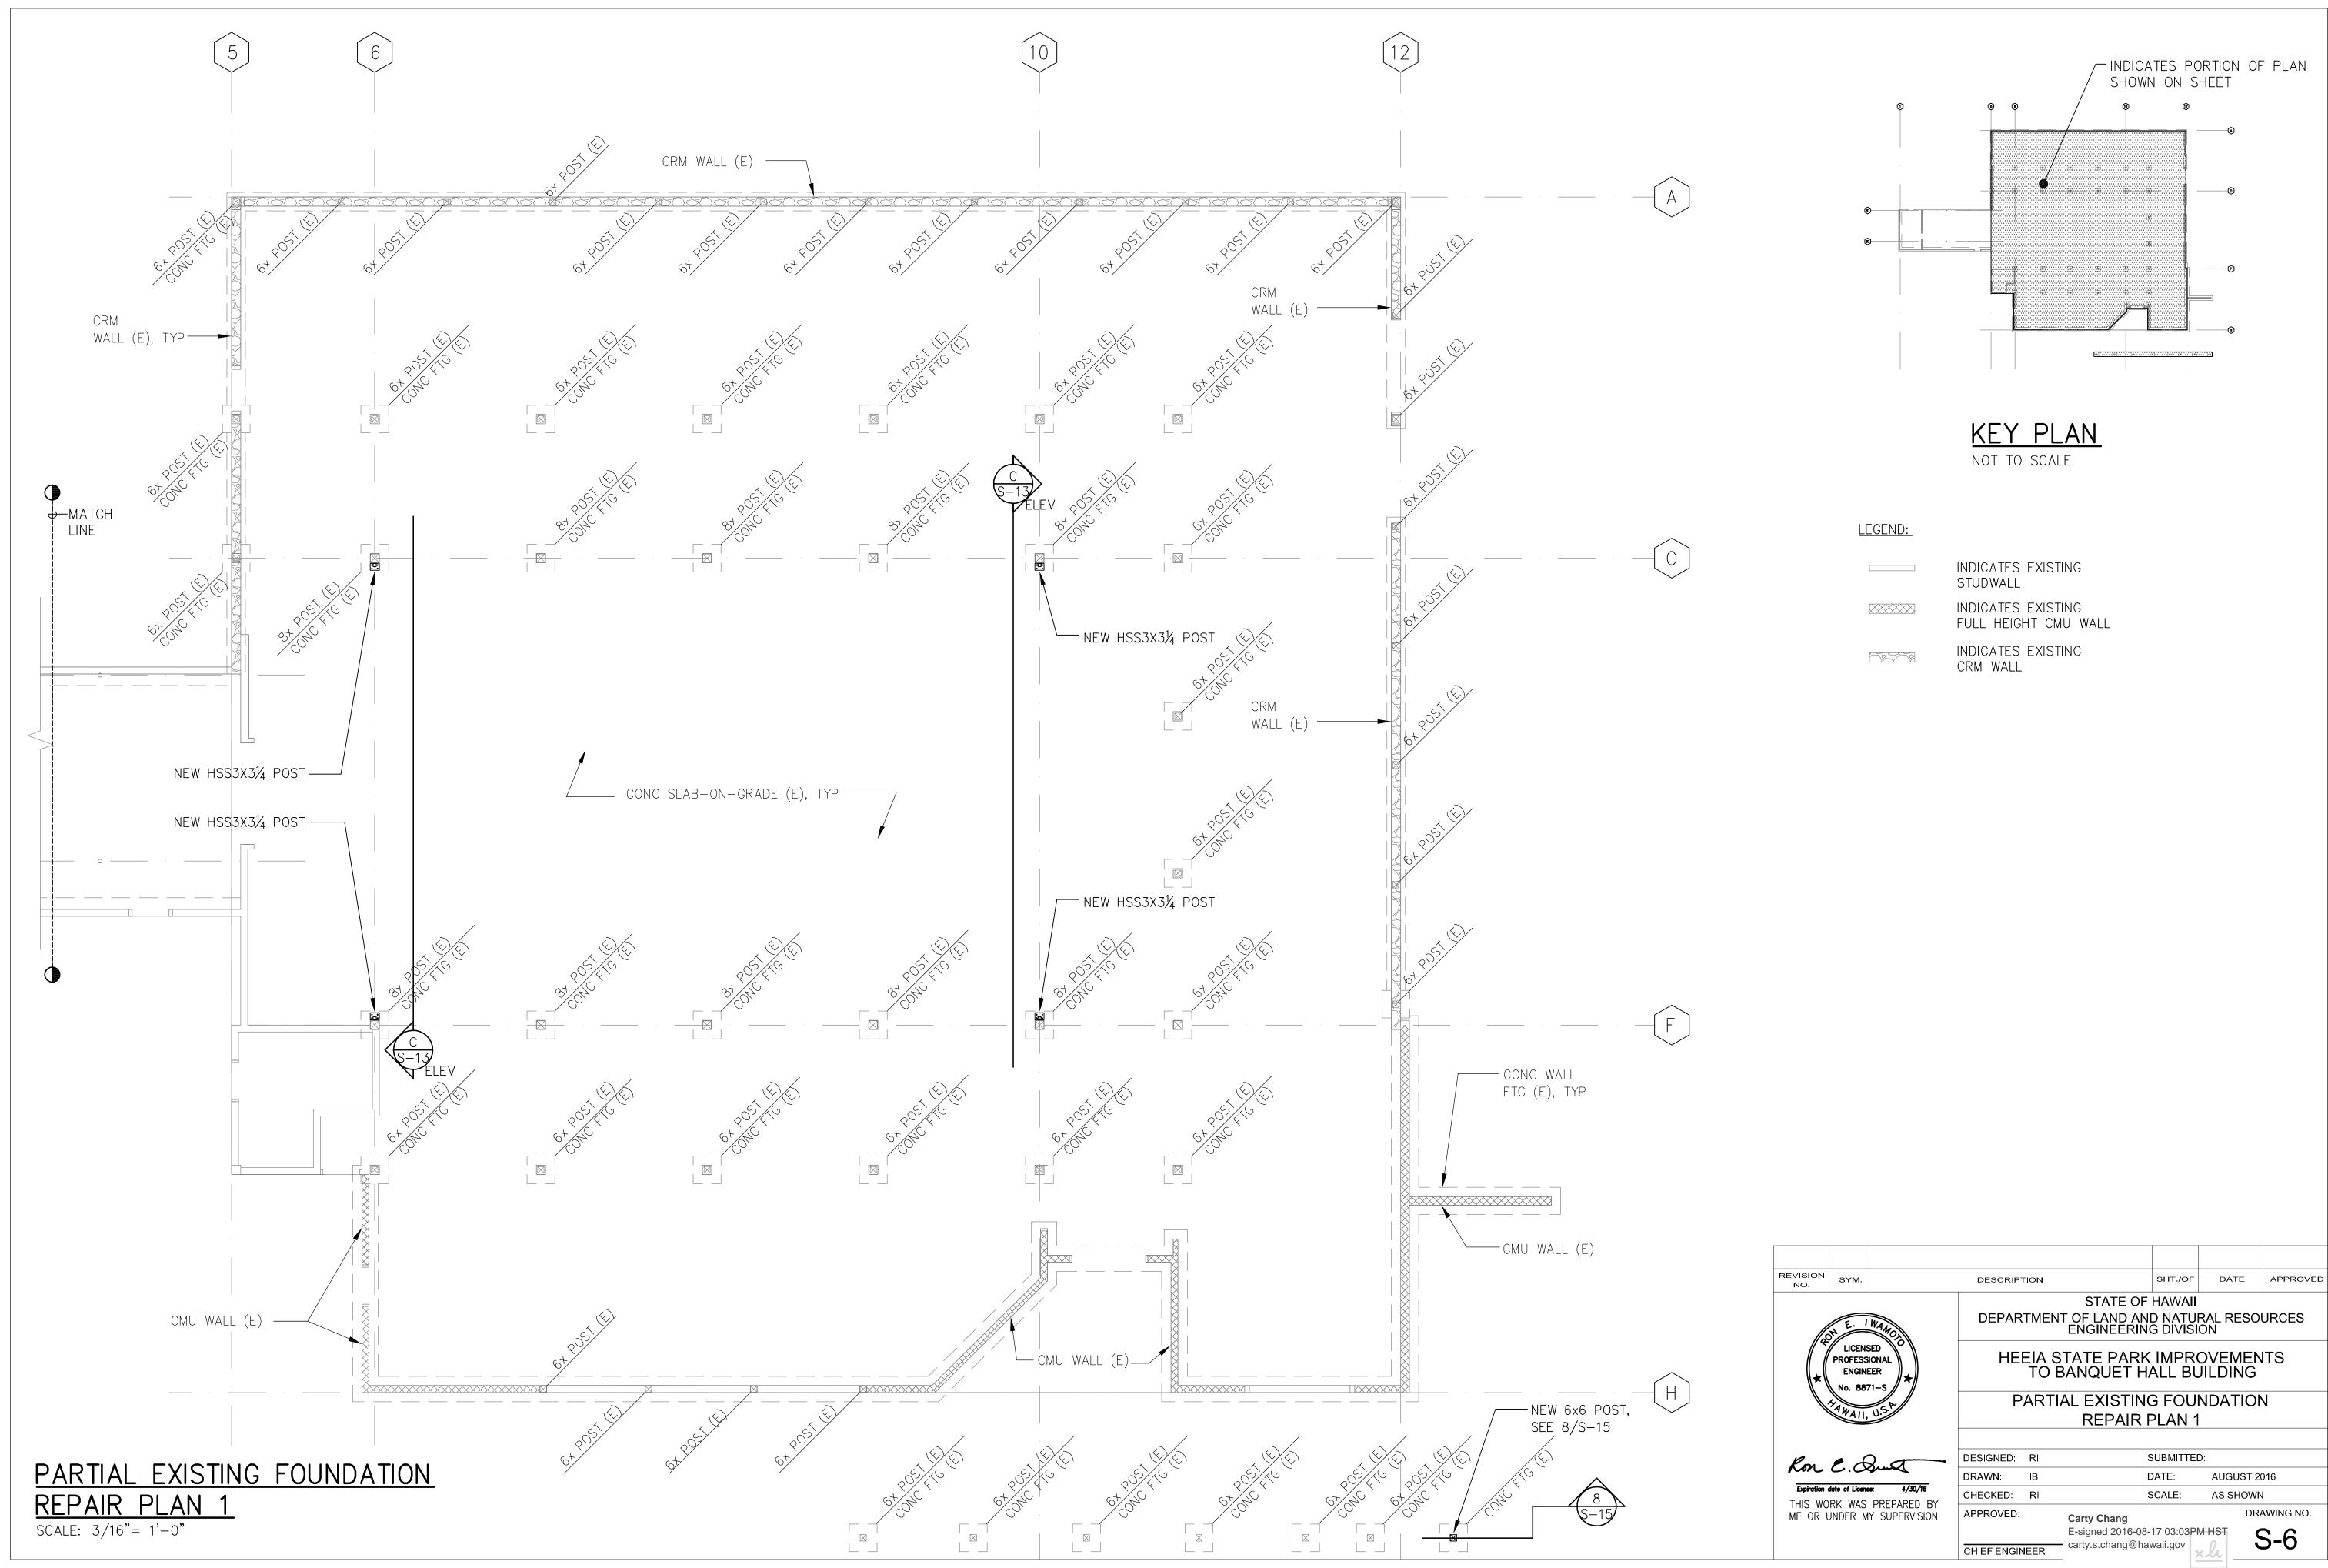

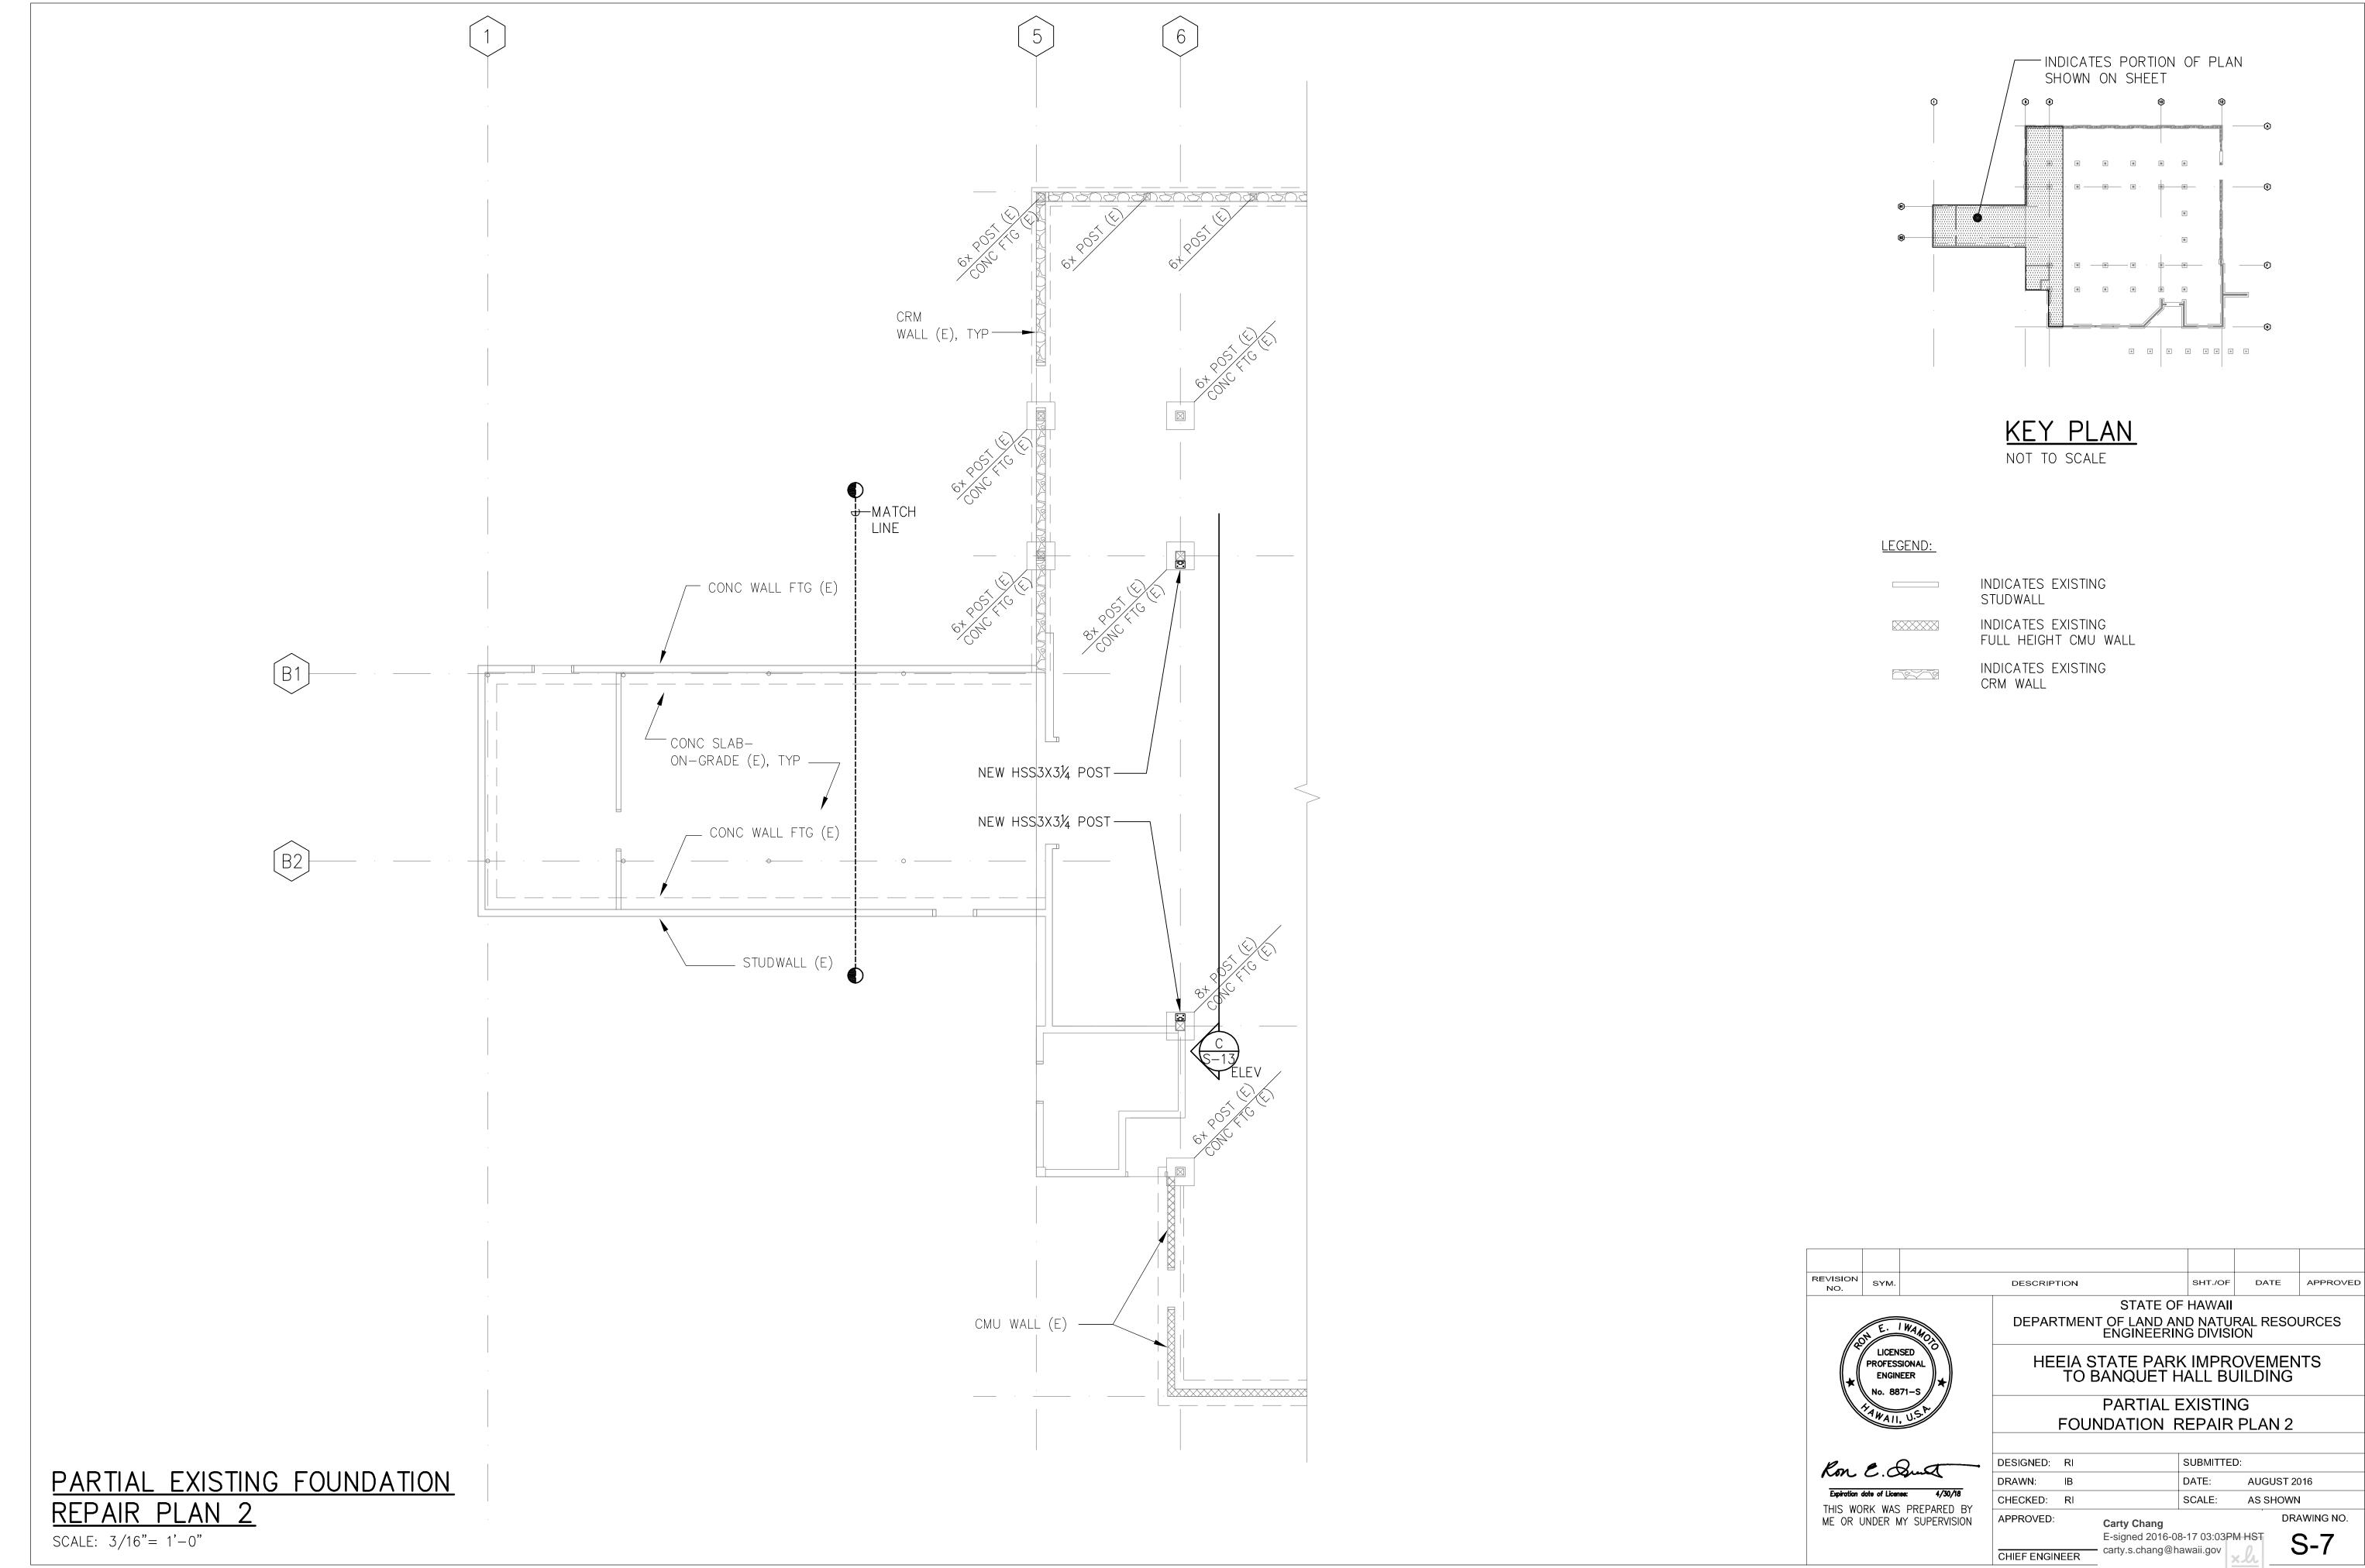

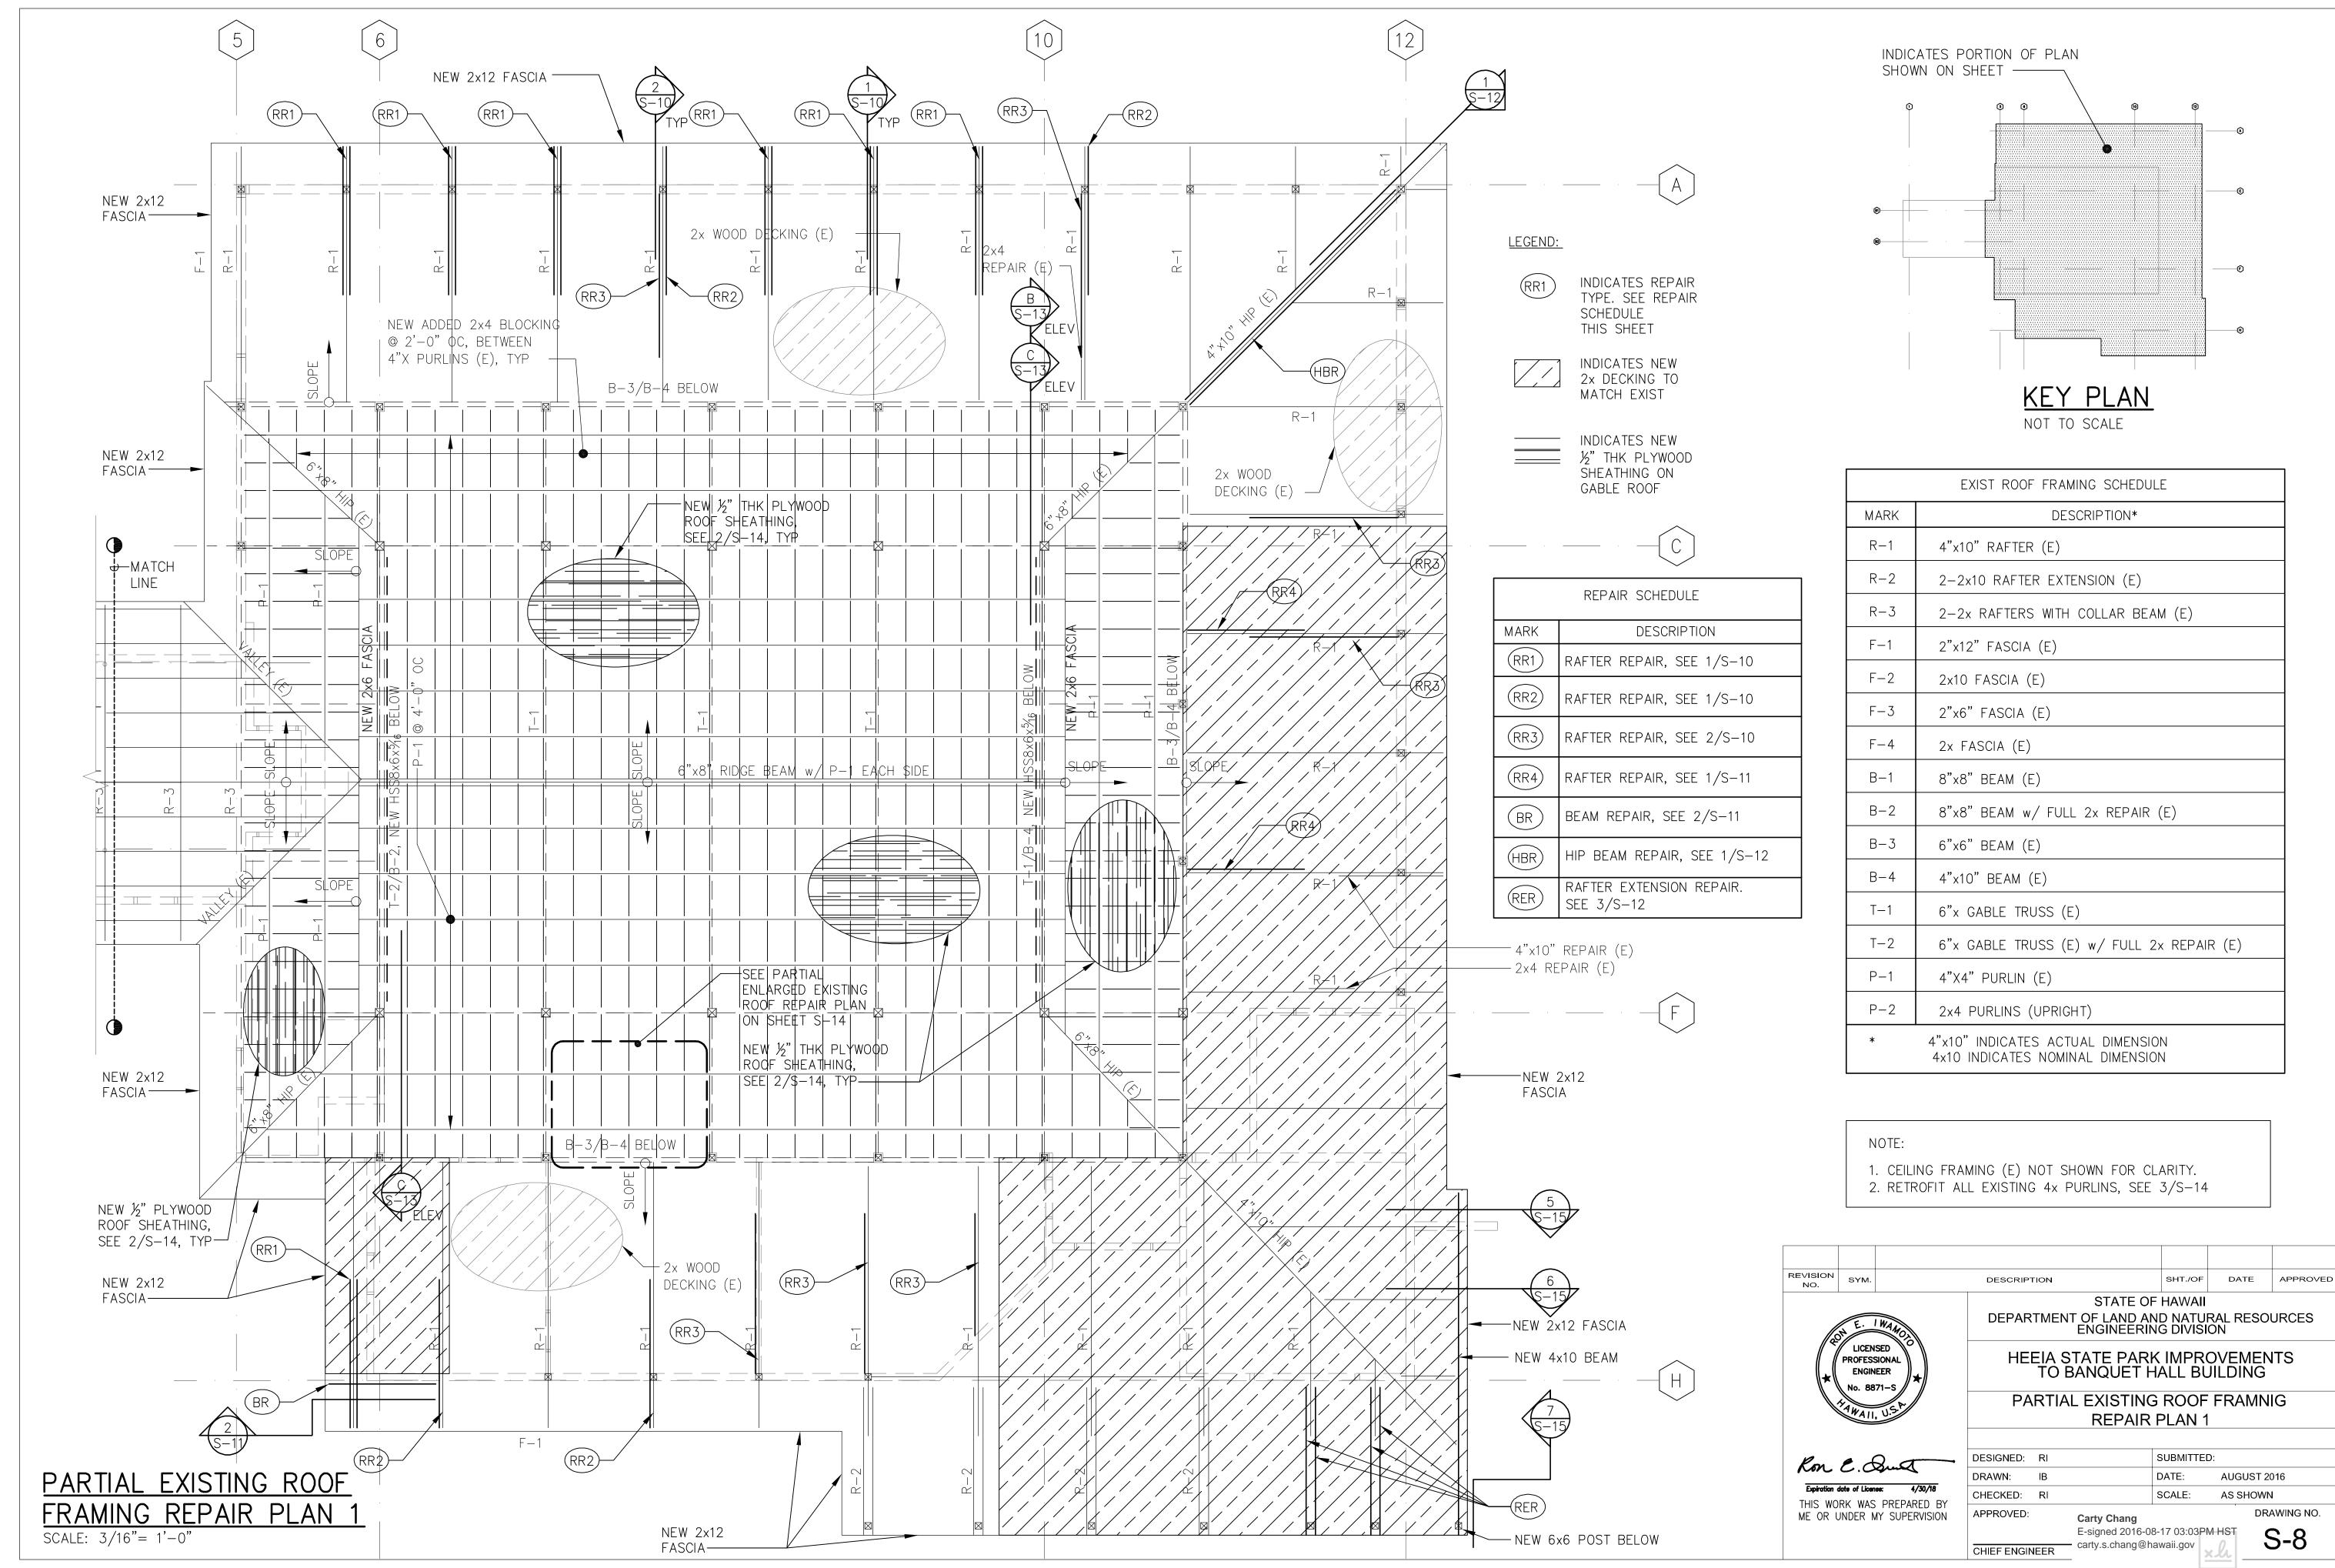

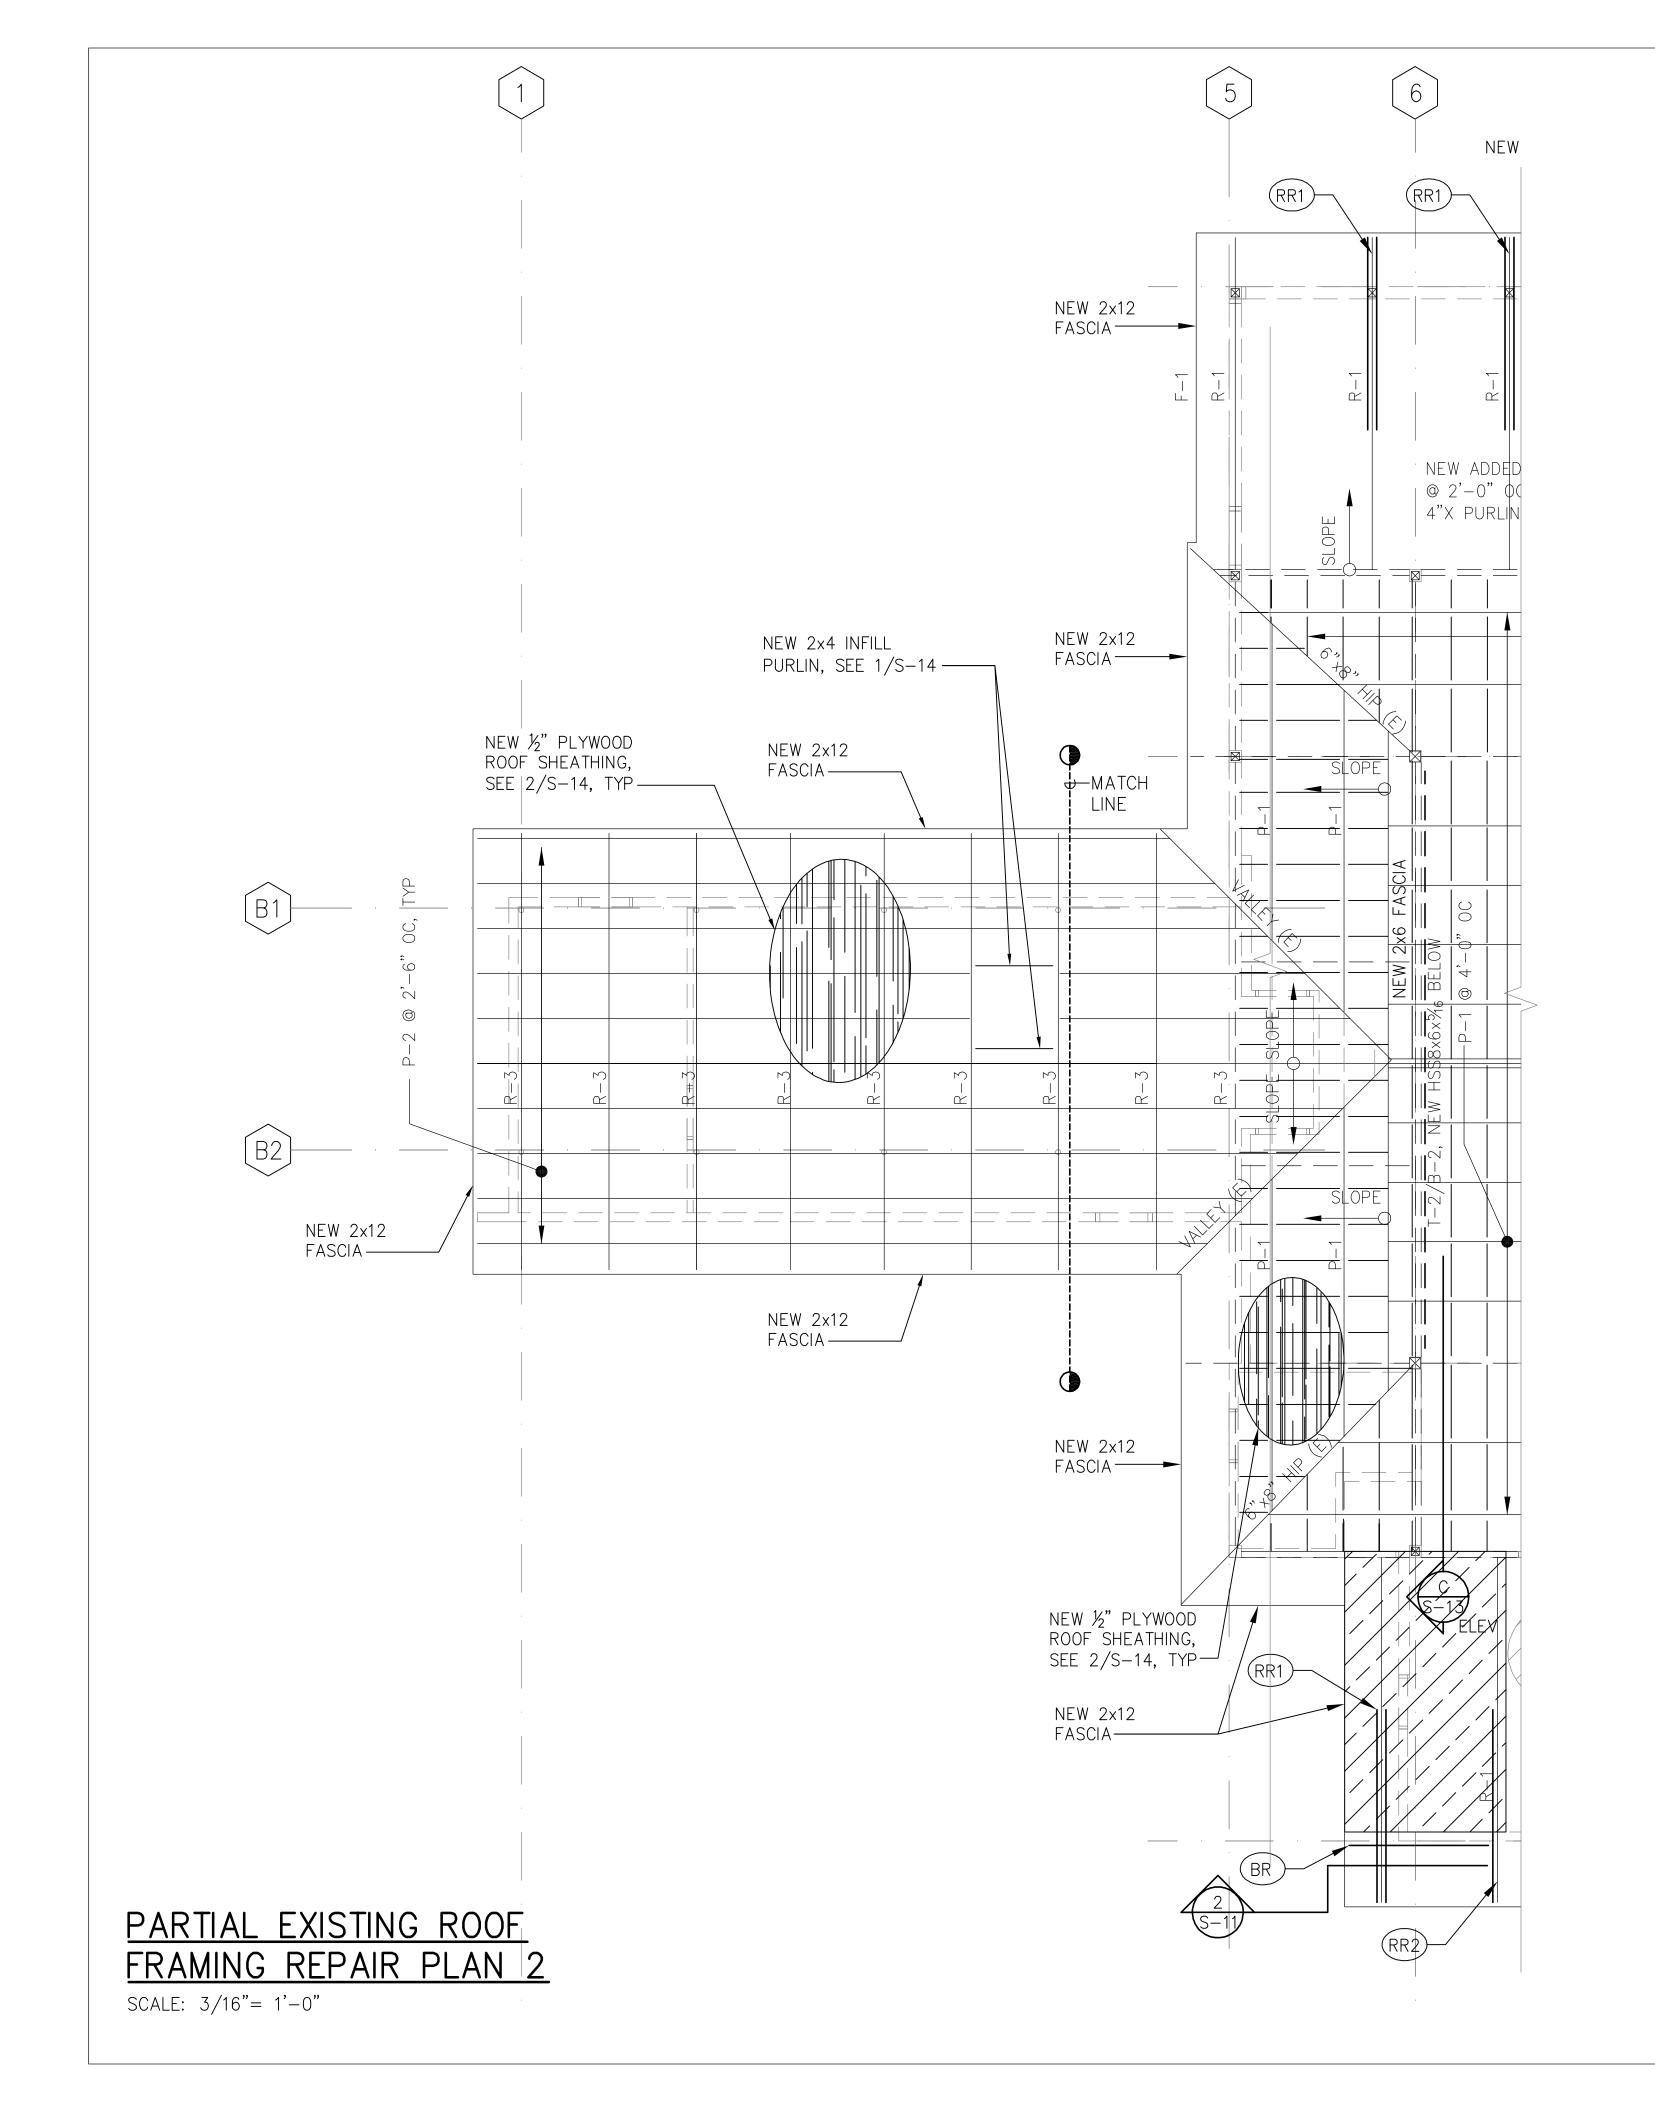


EXIST ROOF FRAMING SCHEDULE		
MARK	DESCRIPTION*	
R-1	4"x10" RAFTER (E)	
R-2	2-2×10 RAFTER EXTENSION (E)	
R-3	2-2x RAFTERS WITH COLLAR BEAM (E)	
F-1	2"x12" FASCIA (E)	
F-2	2x10 FASCIA (E)	
F-3	2"x6" FASCIA (E)	
F-4	2x FASCIA (E)	
B-1	8"x8" BEAM (E)	
B-2	8"x8" BEAM w/ FULL 2x REPAIR (E)	
B-3	6"x6" BEAM (E)	
B-4	4"x10" BEAM (E)	
T-1	6"x GABLE TRUSS (E)	
T-2	6"x GABLE TRUSS (E) w/ FULL 2x REPAIR (E)	
P-1	4"X4" PURLIN (E)	
P-2	2x4 PURLINS (UPRIGHT)	
*	4"x10" INDICATES ACTUAL DIMENSION 4x10 INDICATES NOMINAL DIMENSION	

REPAIR SCHEDULE		
MARK	DESCRIPTION	
(RR1)	RAFTER REPAIR, SEE 1/S-10	
(RR2)	RAFTER REPAIR, SEE 1/S-10	
(RR3)	RAFTER REPAIR, SEE 2/S-10	
(RR4)	RAFTER REPAIR, SEE 1/S-11	
BR	BEAM REPAIR, SEE 2/S-11	
(HBR)	HIP BEAM REPAIR, SEE 1/S-12	
RER	RAFTER EXTENSION REPAIR. SEE 3/S-12	

NOTE:

CEILING FRAMING (E) NOT SHOWN FOR CLARITY.
 RETROFIT ALL EXISTING 4x PURLINS, SEE 3/S-14

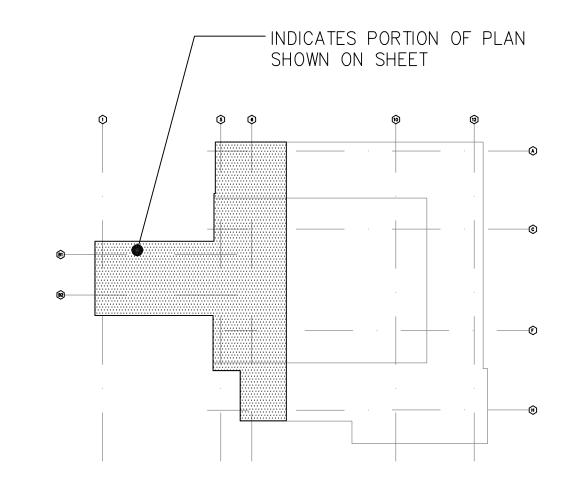

KEY PLAN

NOT TO SCALE

LEGEND:




INDICATES REPAIR TYPE. SEE REPAIR SCHEDULE THIS SHEET



INDICATES NEW 2x DECKING TO MATCH EXIST



INDICATES NEW
½" THK PLYWOOD
SHEATHING ON
GABLE ROOF

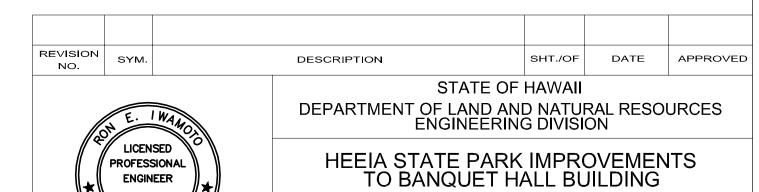

PARTIAL EXISTING ROOF FRAMNIG REPAIR PLAN 2

Expiration date of License: 4/30/18

THIS WORK WAS PREPARED BY ME OR UNDER MY SUPERVISION

DESIGNED: RI

DRAWN: IB

CHECKED: RI

APPROVED:

Carty Chang

E-signed 2016-08-17 03:03PM HST
CARTY.s.chang@hawaii.gov

CHIEF ENGINEER

SUBMITTED:


AUGUST 2016


BRAWING NO.

Carty Chang


E-signed 2016-08-17 03:03PM HST
Carty.s.chang@hawaii.gov


CHIEF ENGINEER

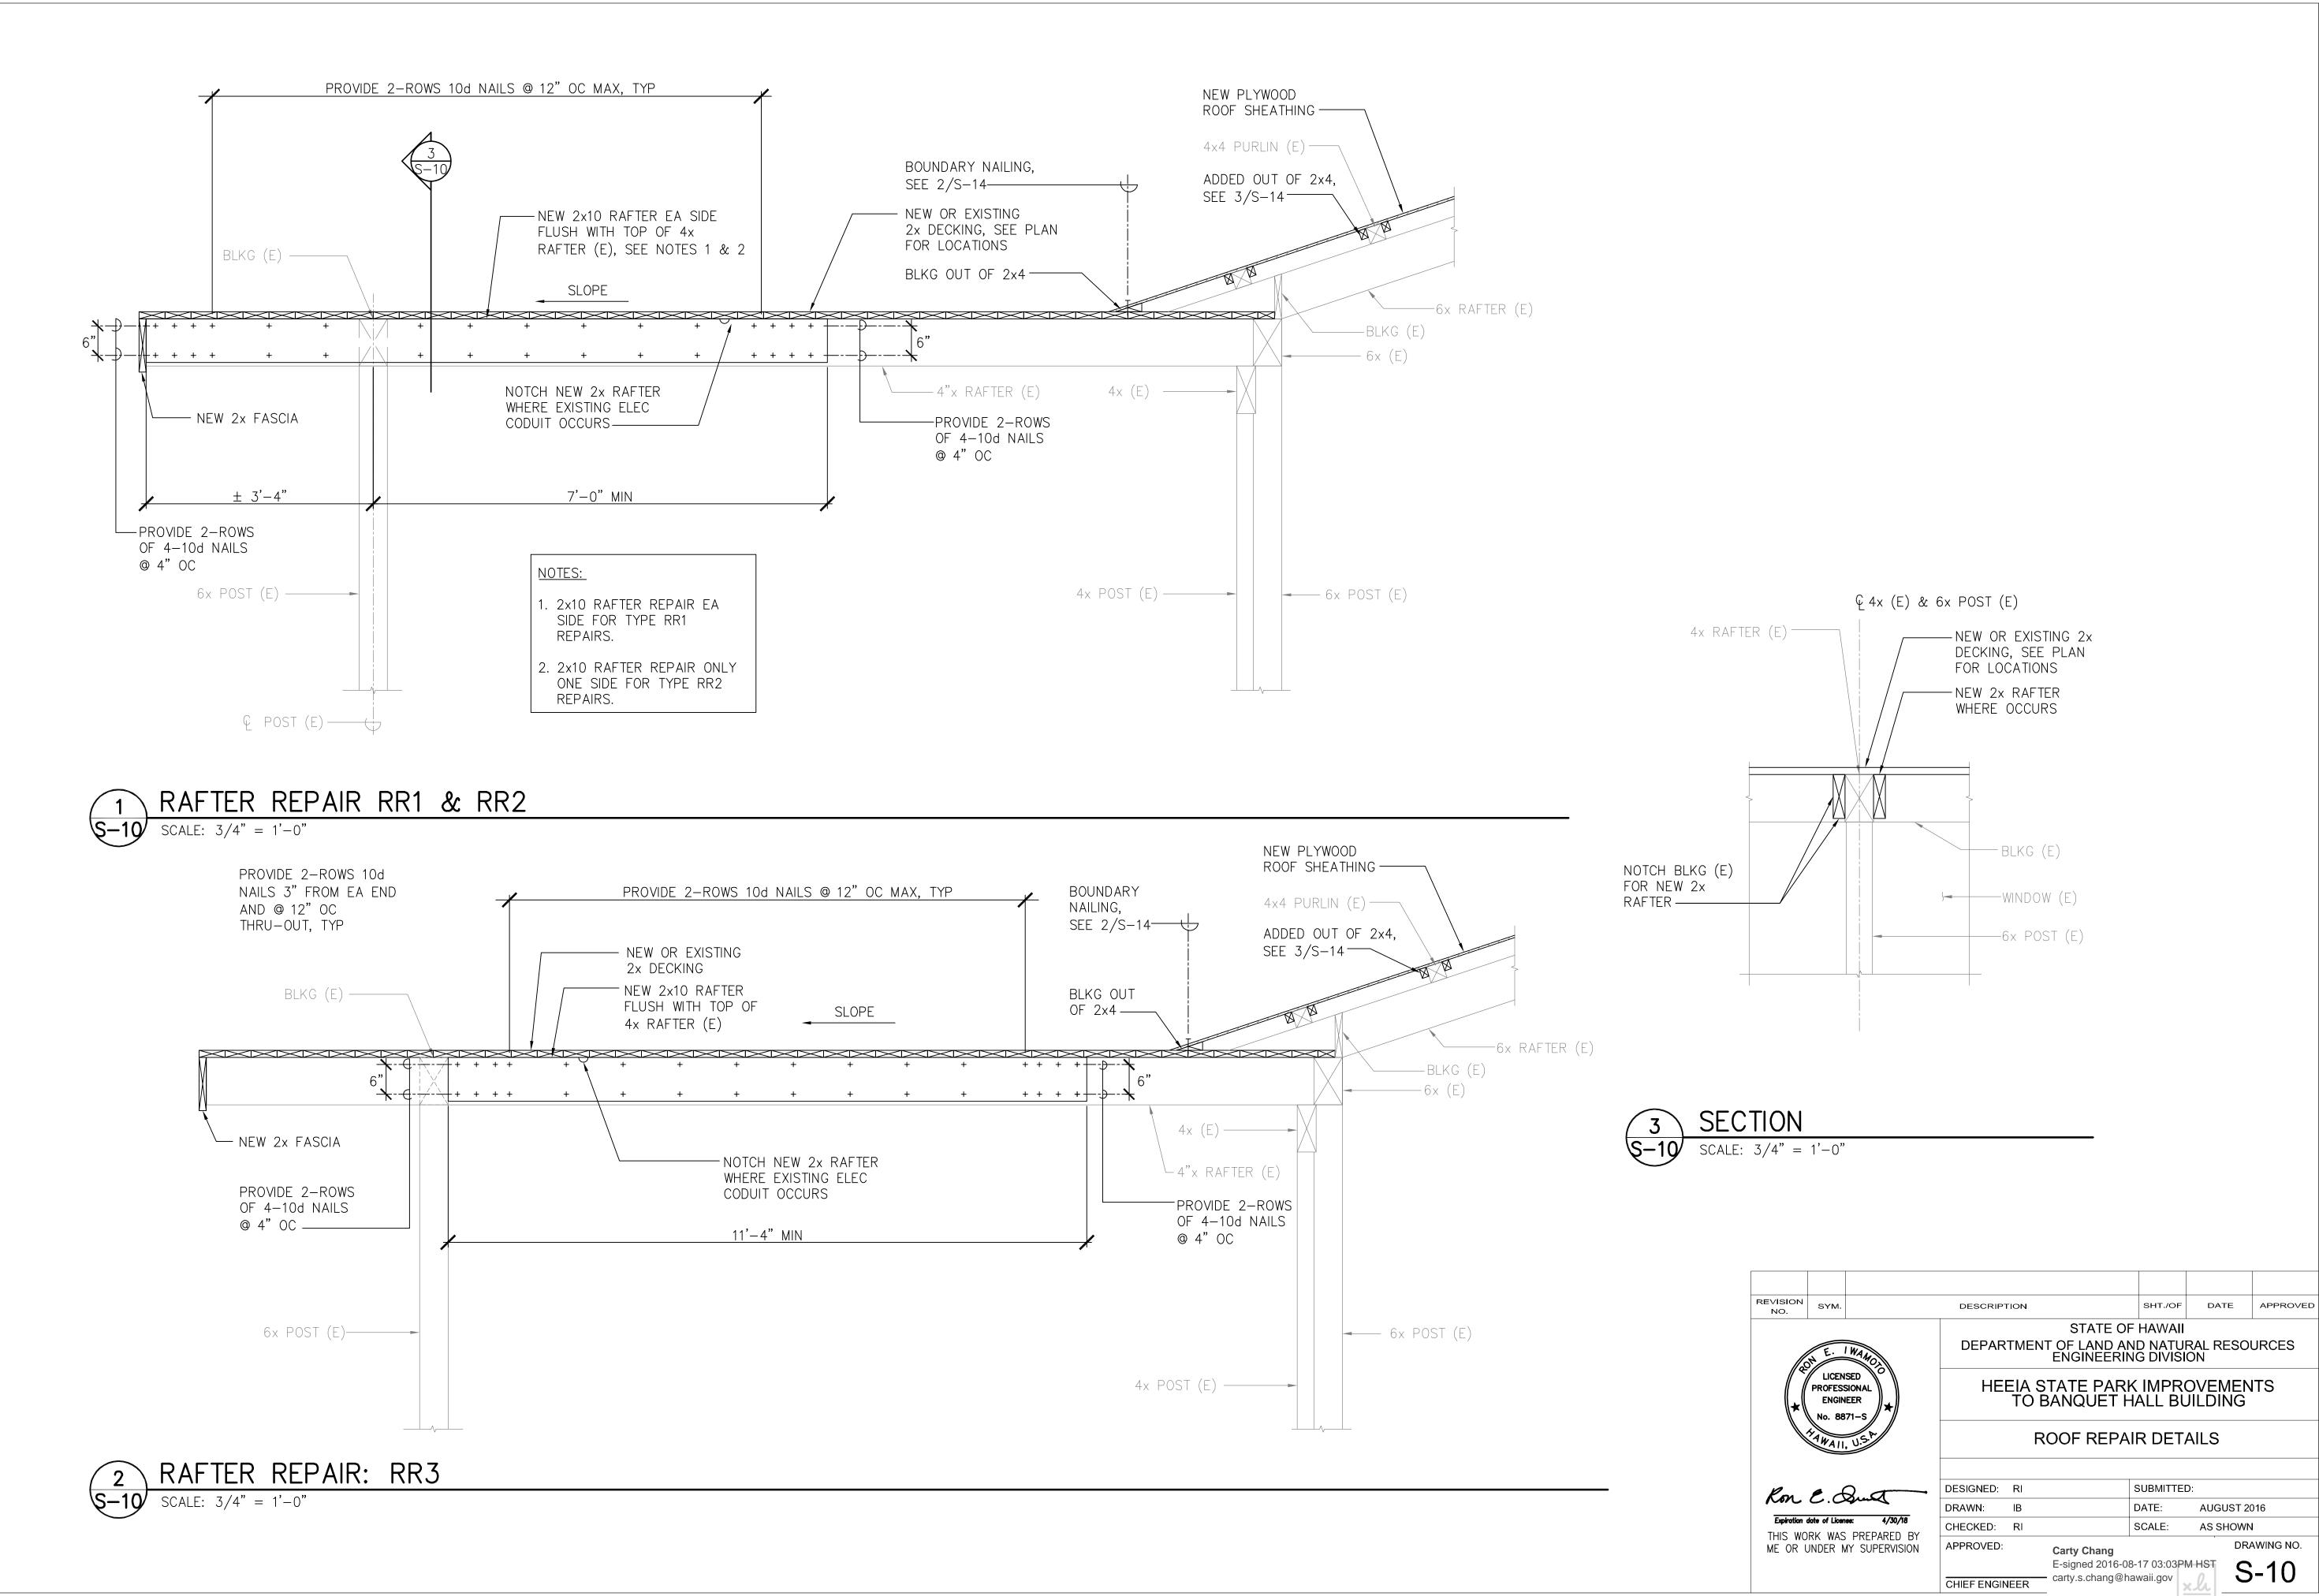

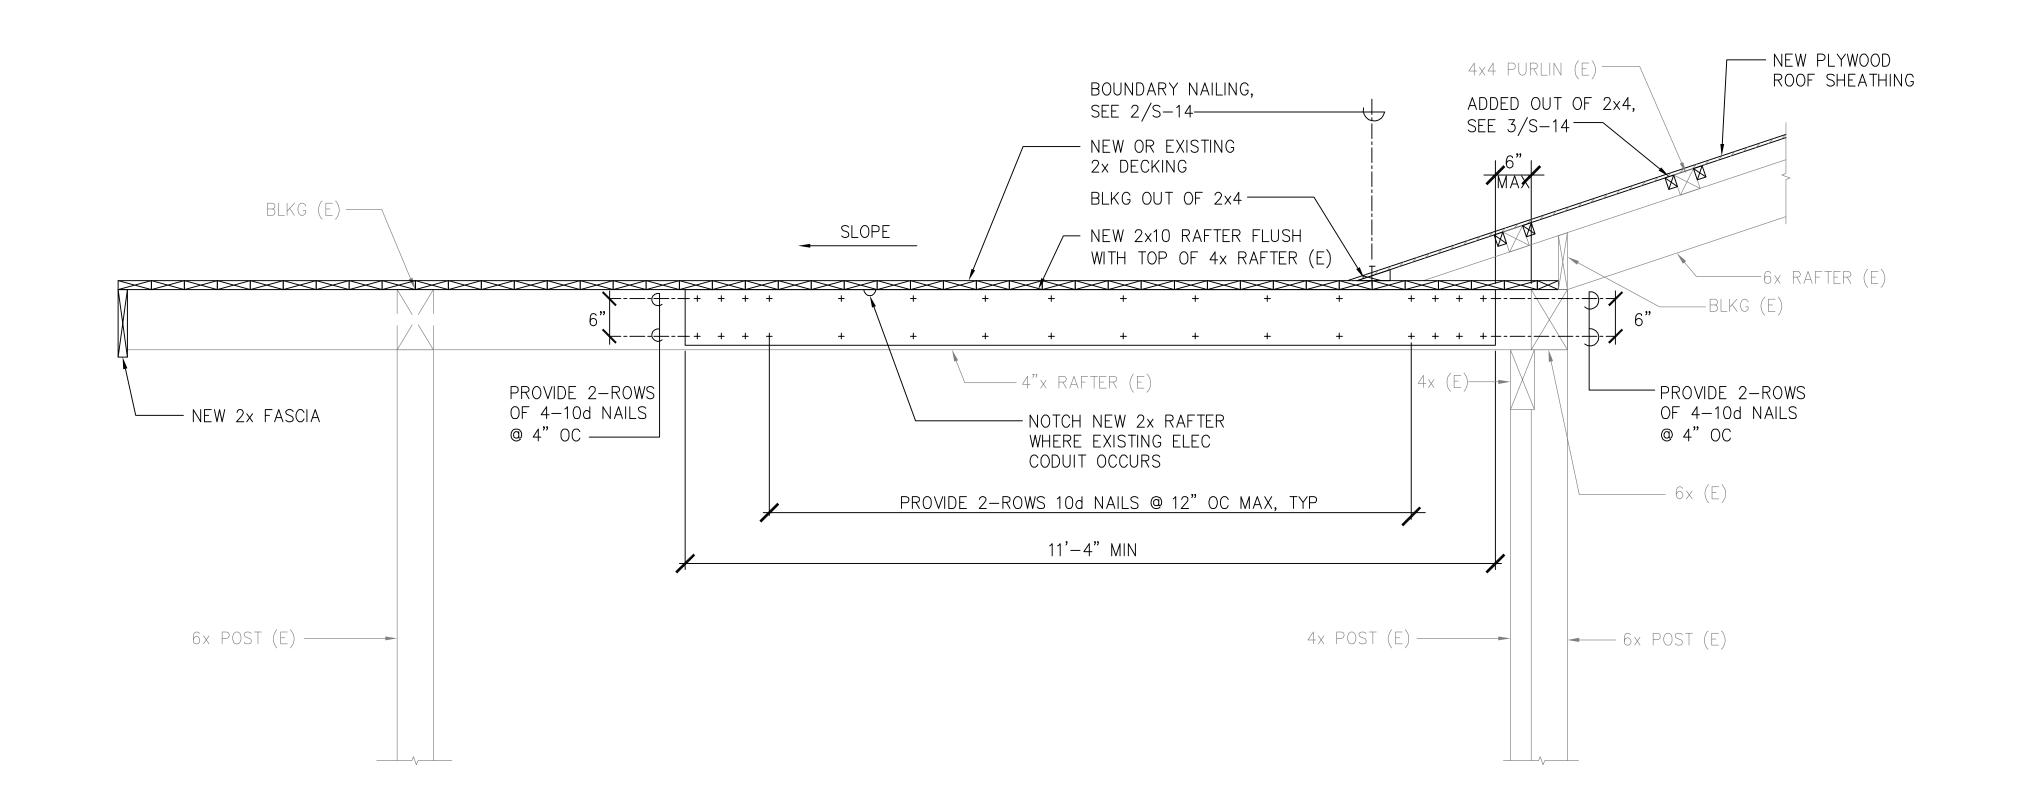


RAFTER REPAIR: RR4 S-11 SCALE: 3/4" = 1'-0"

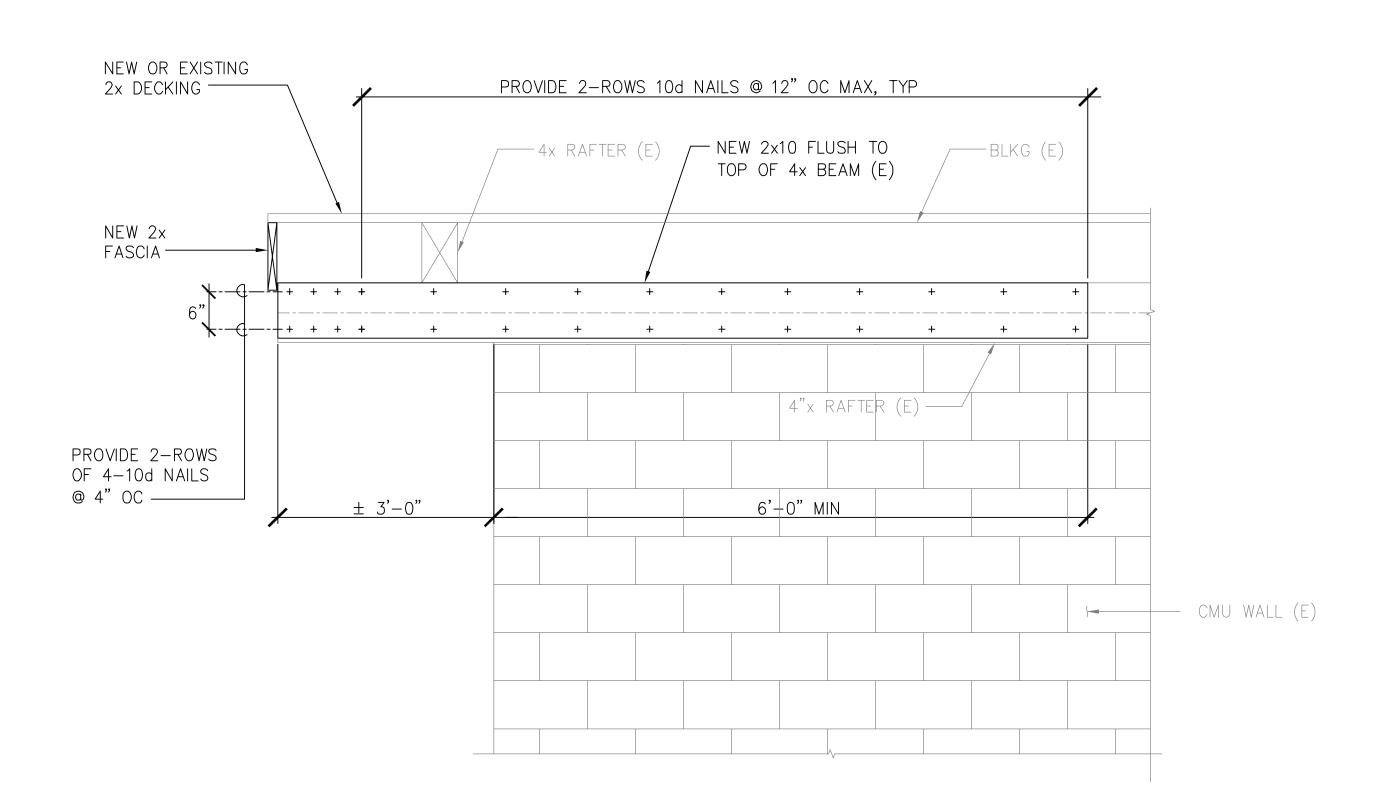


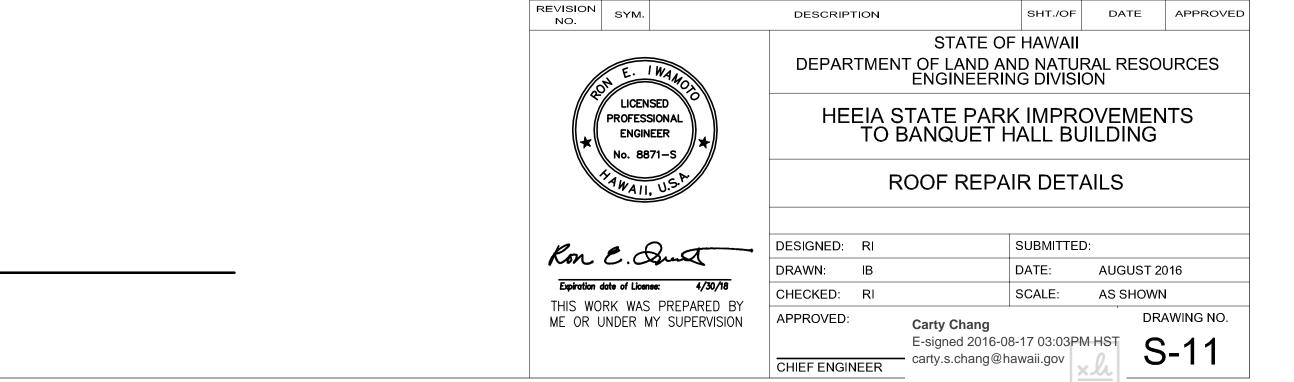


DESCRIPTION

SHT./OF DATE APPROVED

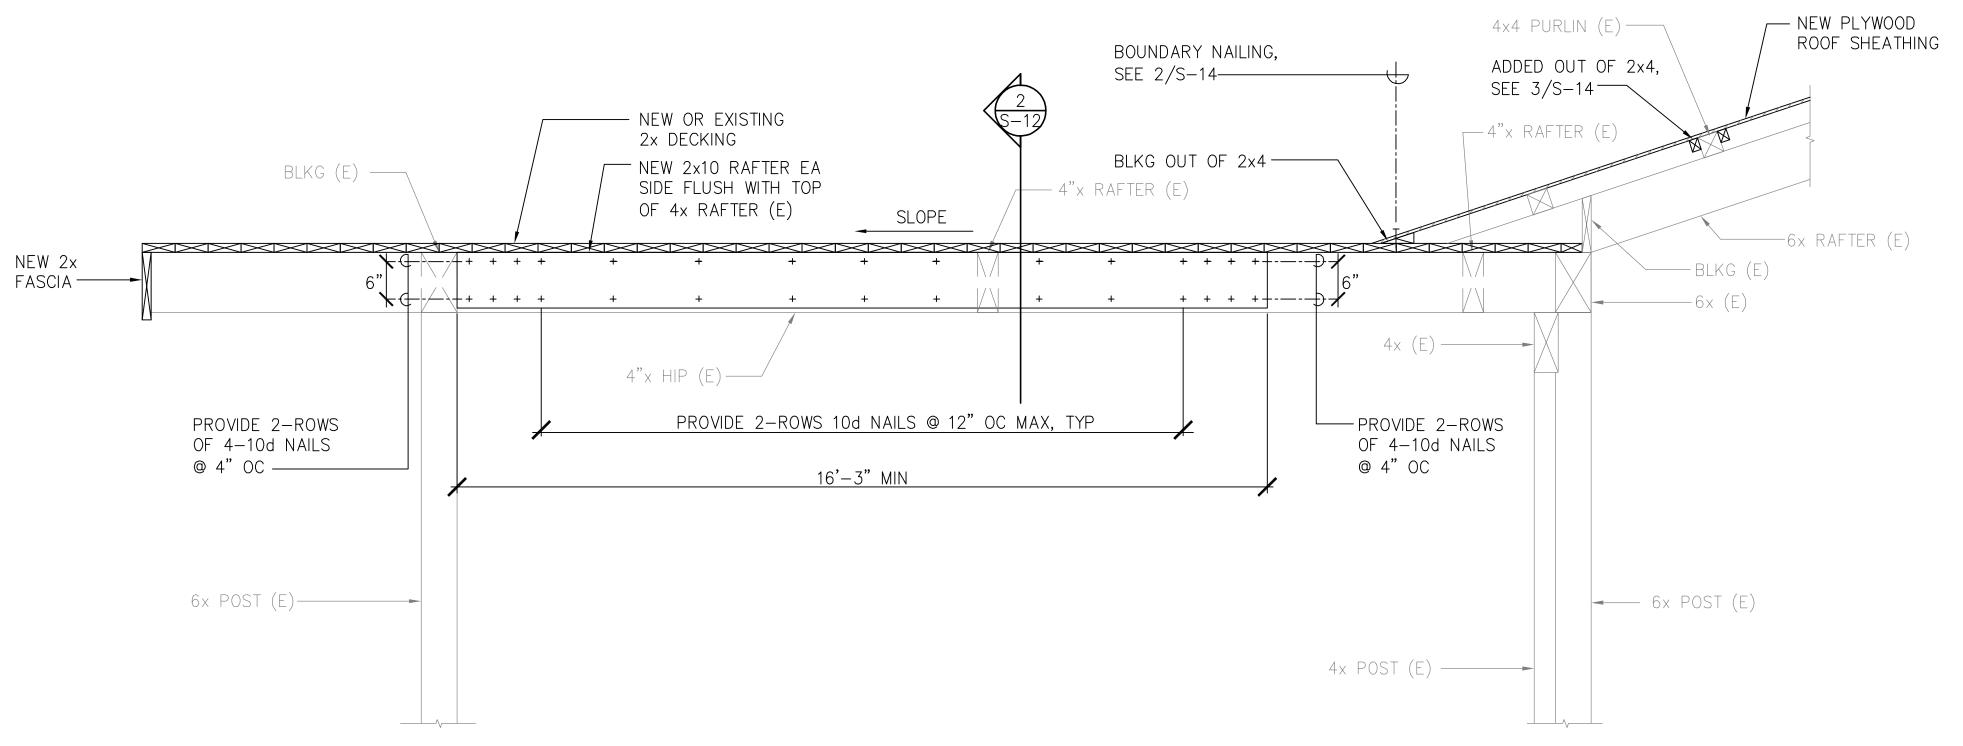

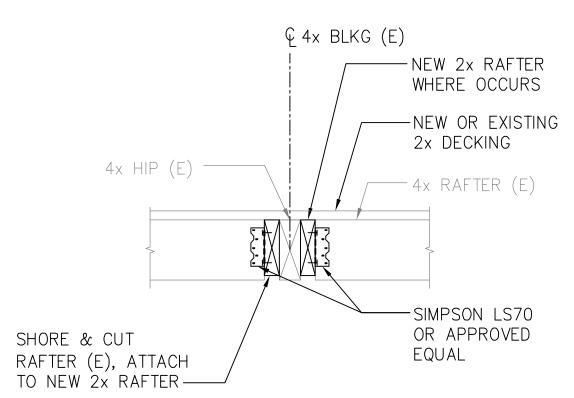


HIP BEAM REPAIR: HBR

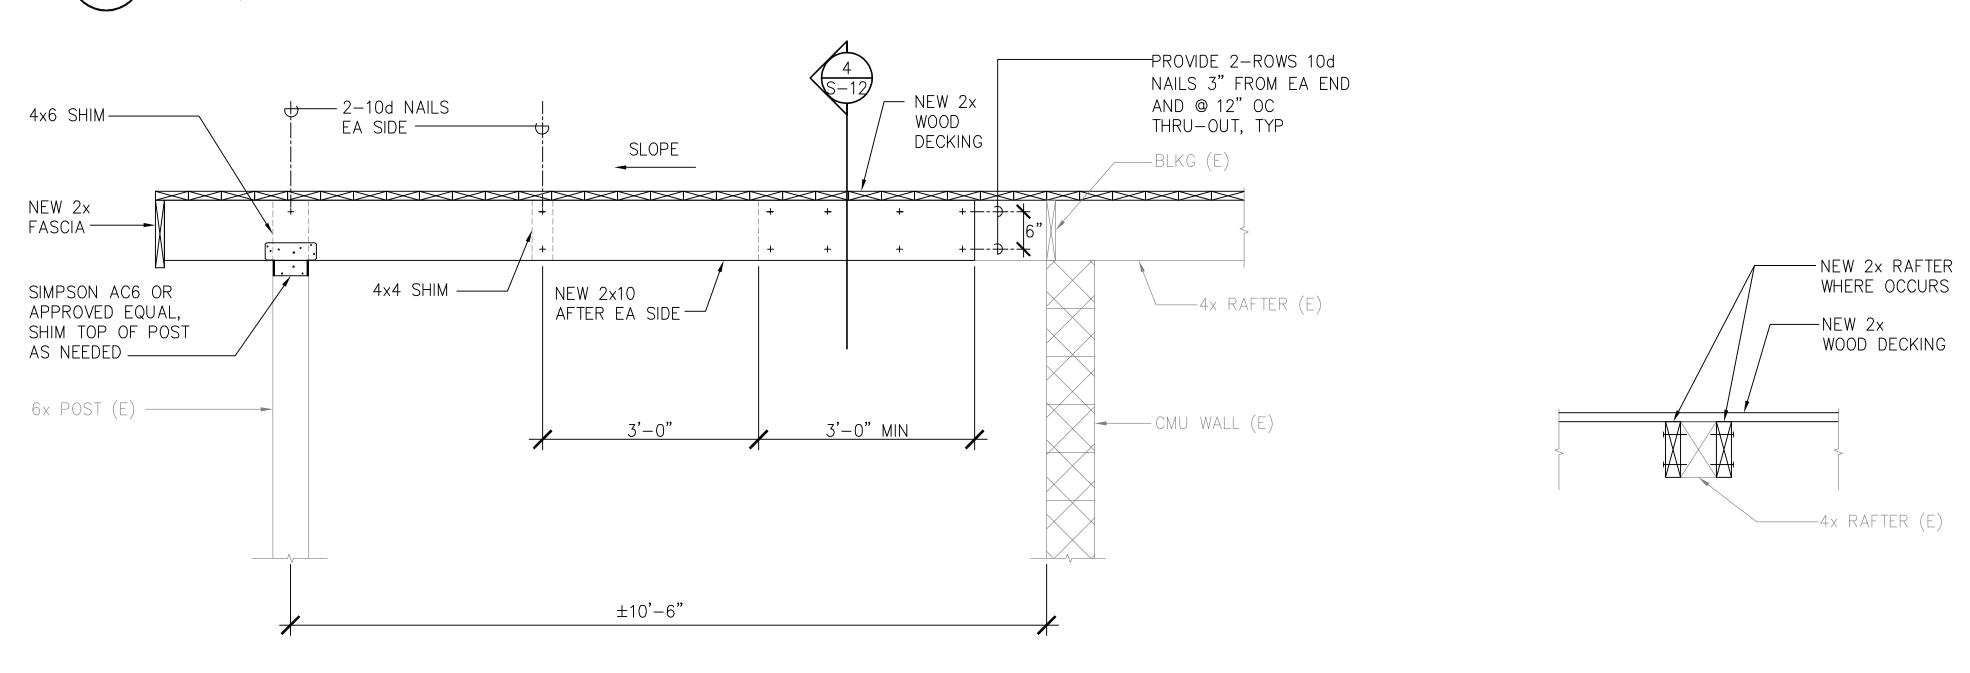



RAFTER EXTENSION REPAIR: RER

SCALE: 3/4" = 1'-0"




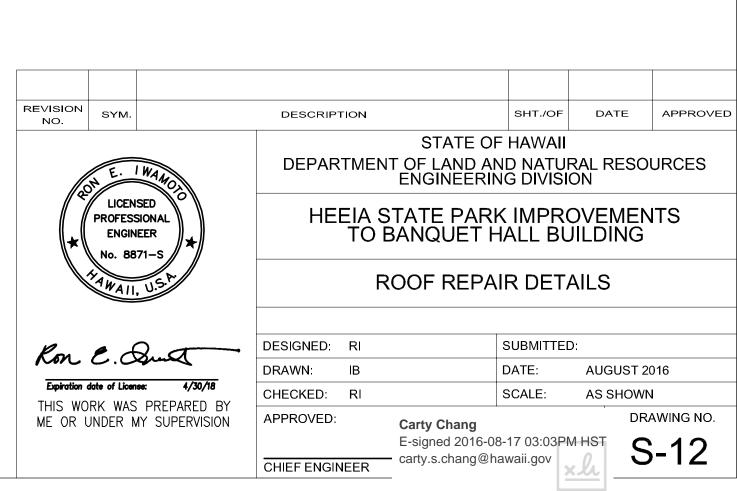

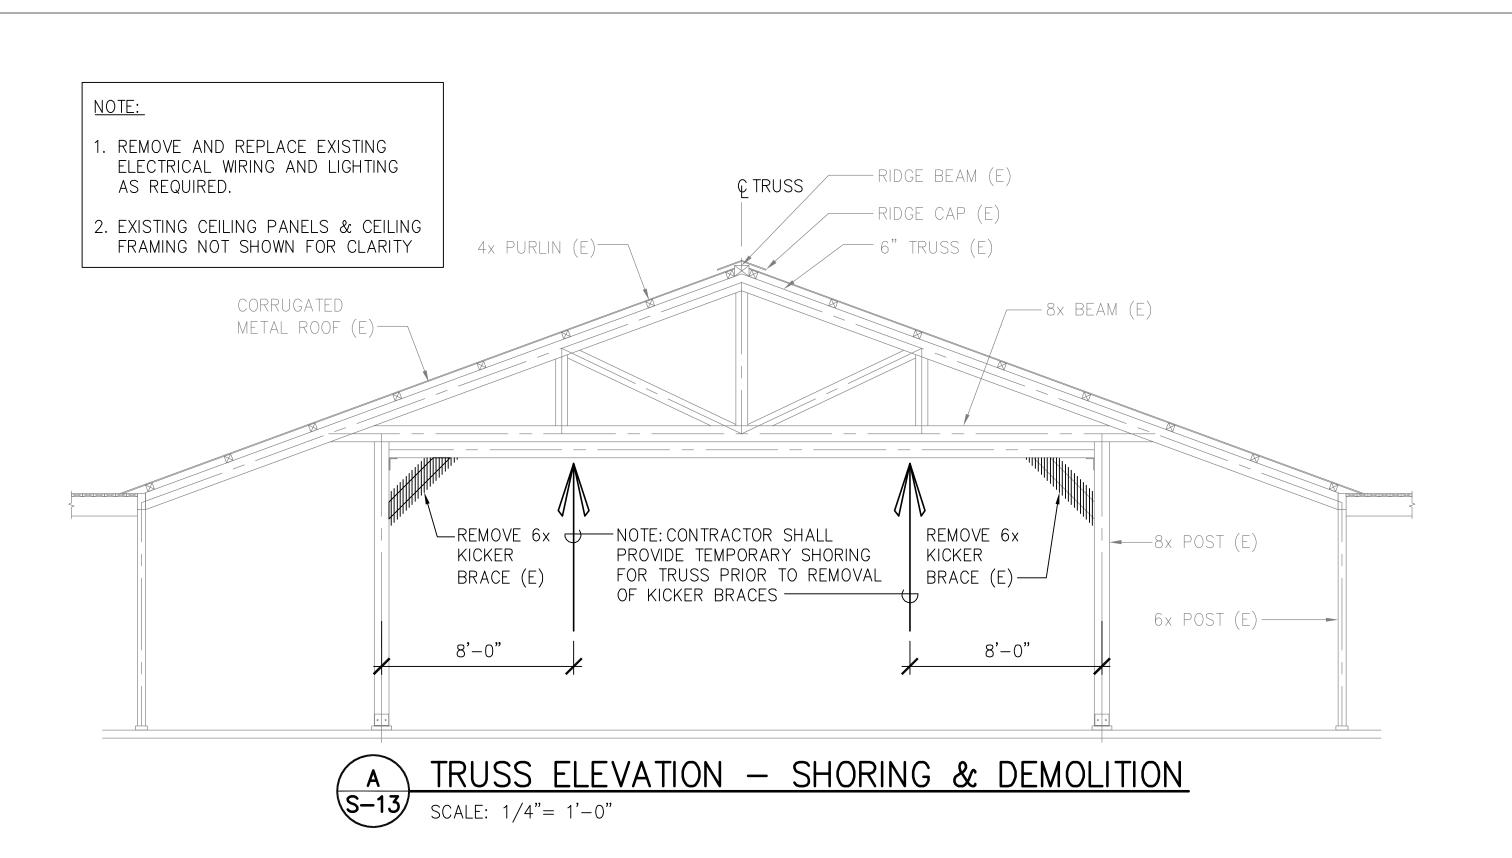


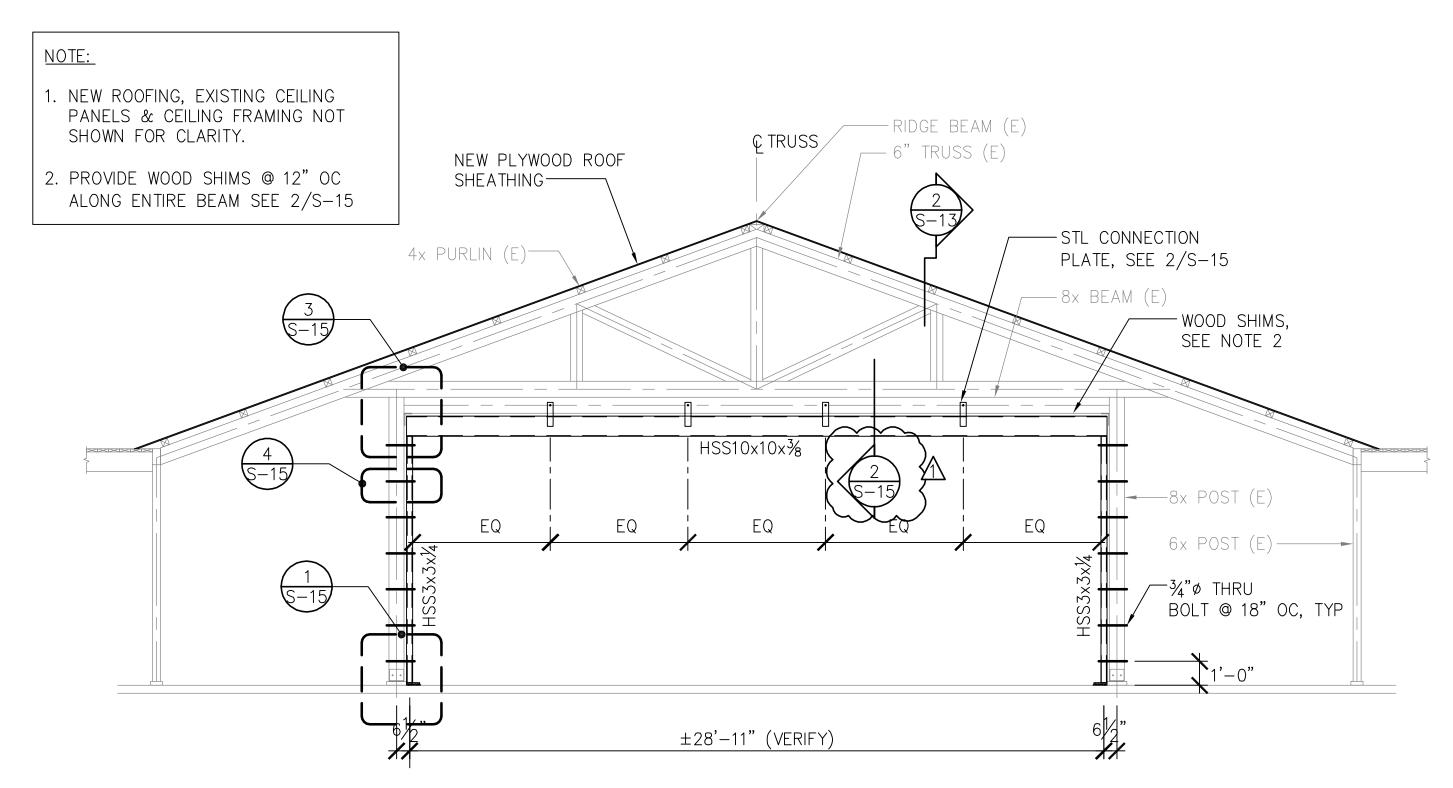





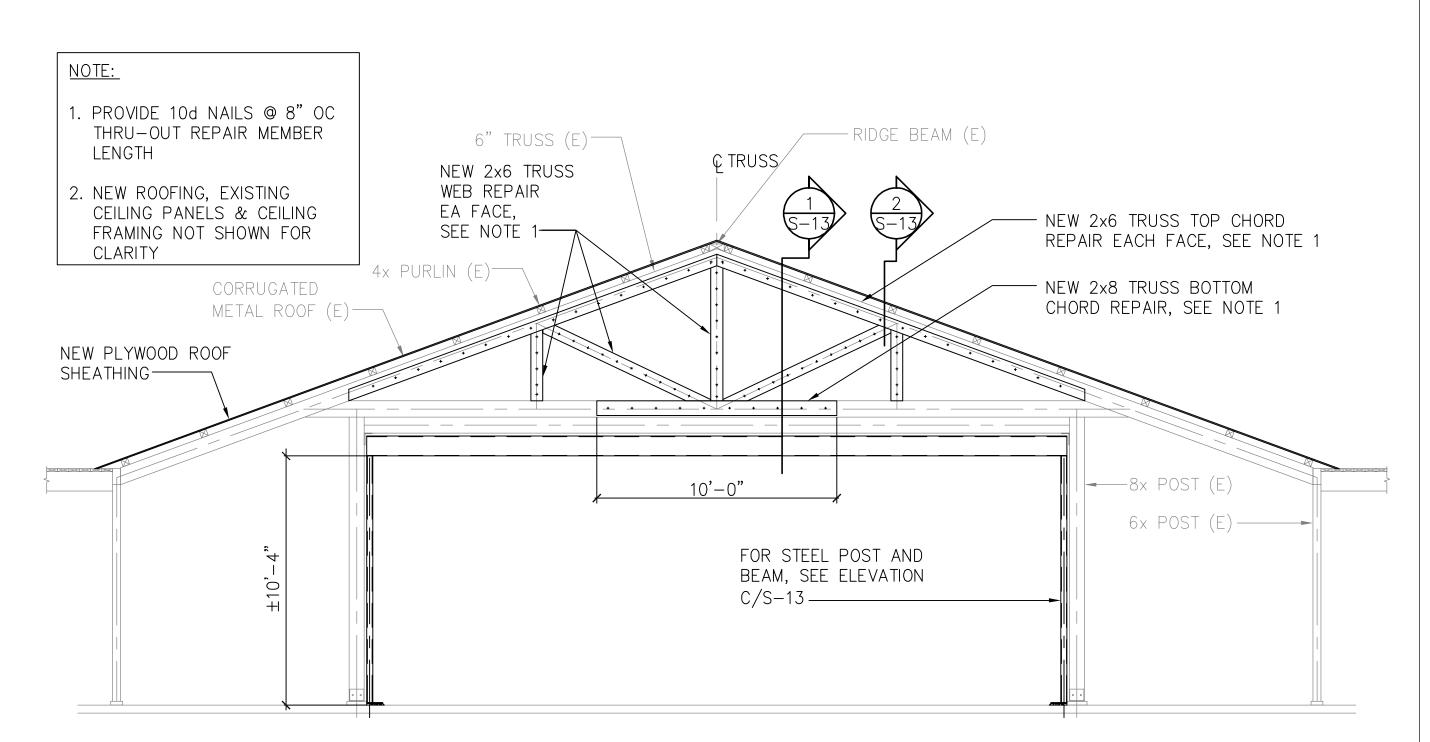



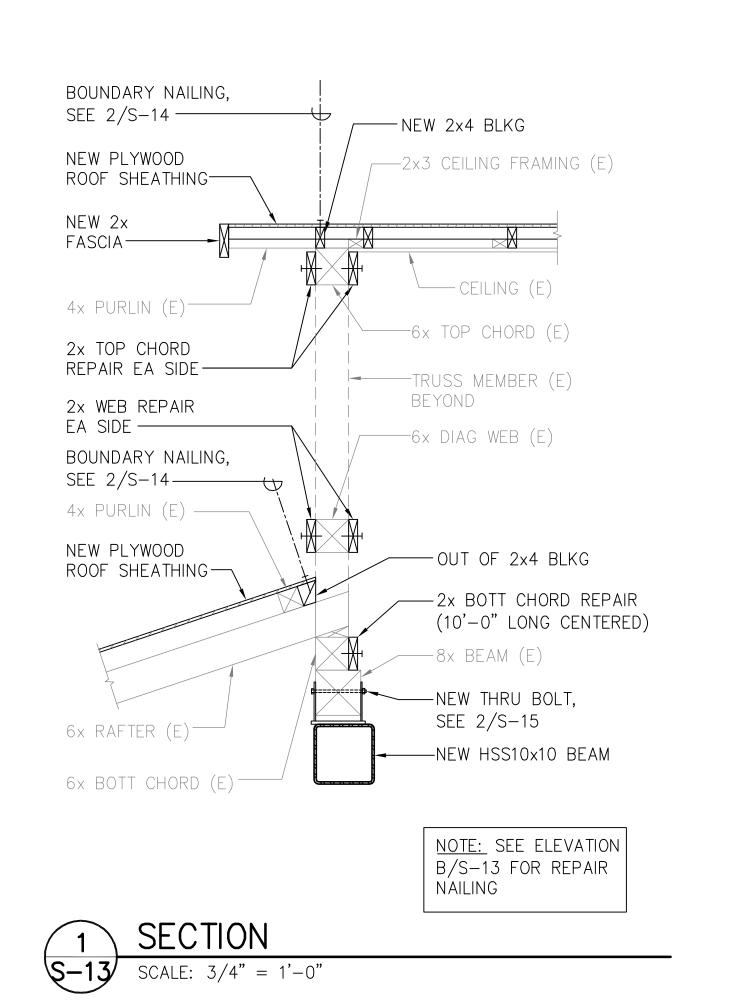

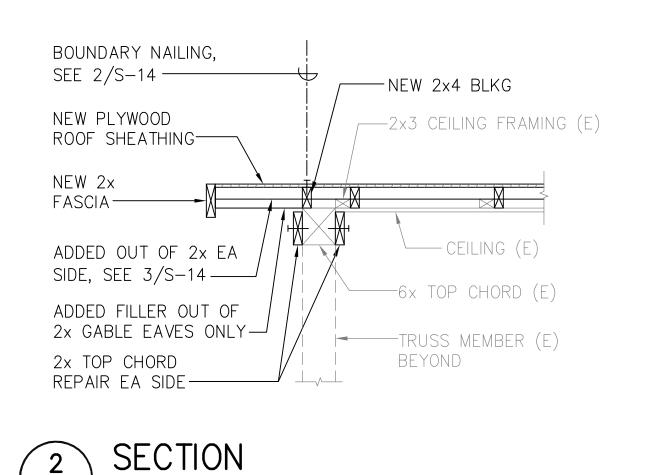

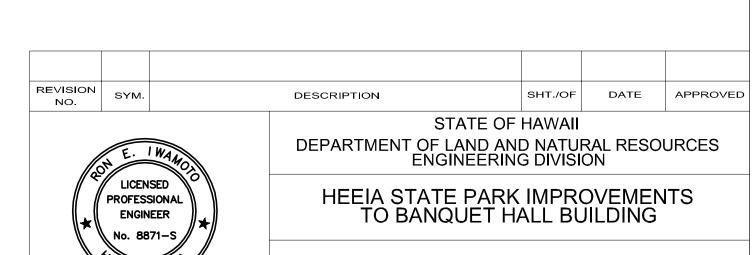


TRUSS ELEVATIONS & SECTION SUBMITTED: DESIGNED: RI Ron E. Quet DRAWN: IB AUGUST 2016 SCALE: AS SHOWN CHECKED: RI THIS WORK WAS PREPARED BY ME OR UNDER MY SUPERVISION DRAWING NO. APPROVED: **Carty Chang** E-signed 2016-08-17 03:03PM HST carty.s.chang@hawaii.gov CHIEF ENGINEER

JOB NO. F27C793A

S-13 SCALE: 3/4" = 1'-0"

SHEET NO. 31 OF 33 SHEETS

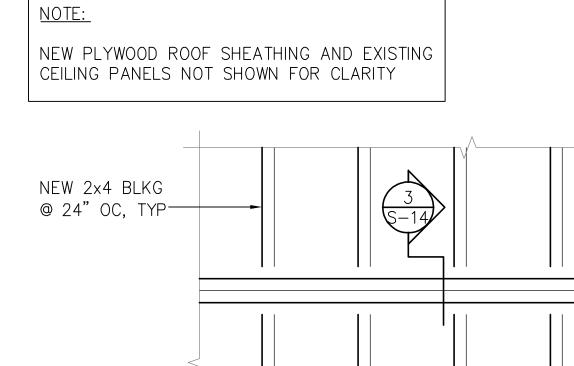



TAPER END OF NEW
2x4 BLKG AND
TOENAIL TO TOP OF
2x DECKING BELOW

NEW OR EXISTING
2x WOOD DECKING
BELOW

ENLARGED ROOF REPAIR PLAN

SCALE: 1/2"= 1'-0"

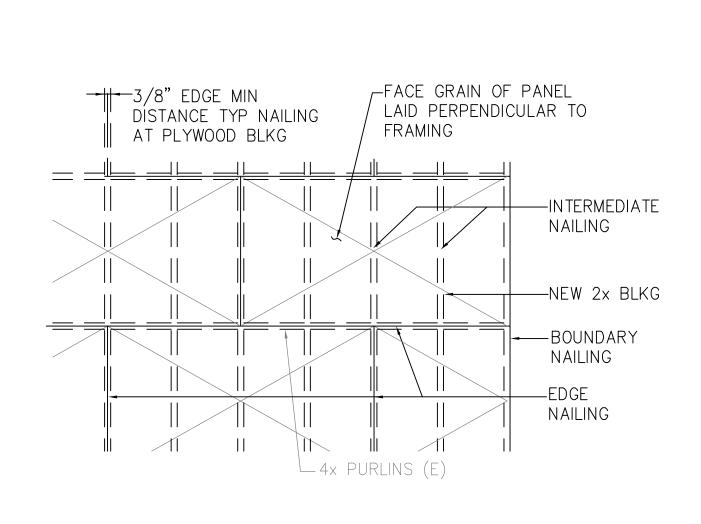

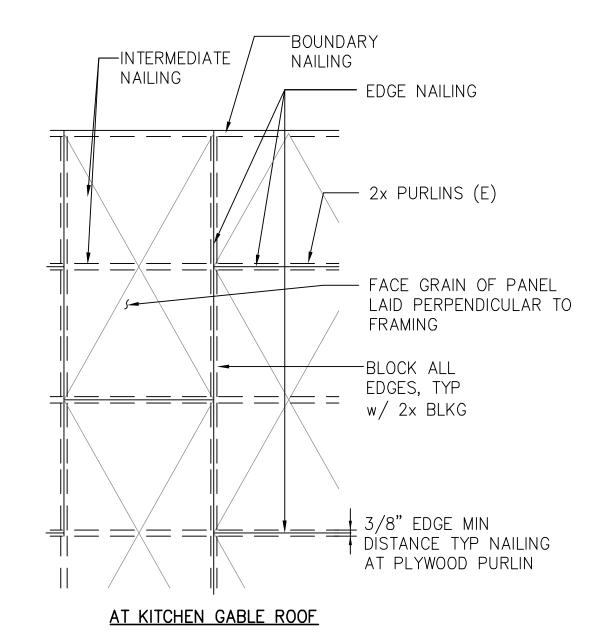

- ADDED OUT OF 2x4

EA SIDE OF 4x (E),

SEE 3/S-14


AT MAIN HALL GABLE ROOF

SHEATHING NAILING			
TYPE	EDGE	BOUNDARIES	INTERMEDIATE
ROOF	8d AT 6"	8d AT 6"	8d AT 12"

SHFATHING NAILING			
TYPE	J		INTERMEDIATE
ROOF	8d AT 6"	8d AT 6"	8d AT 12"


2 PLYWOOD ROOF SHEATHING NAILING


S-14 SCALE: 3/4" = 1'-0"

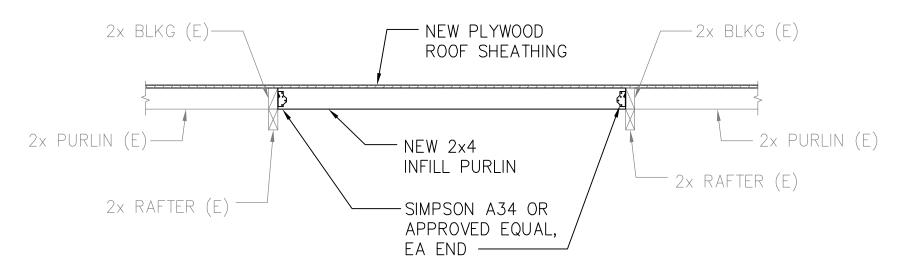

1 INFILL PURLIN DETAIL

SCALE: 3/4" = 1'-0"

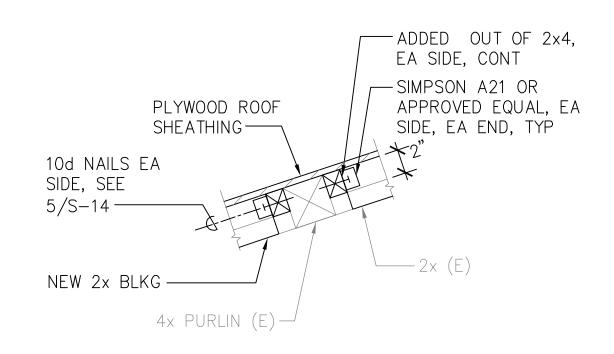


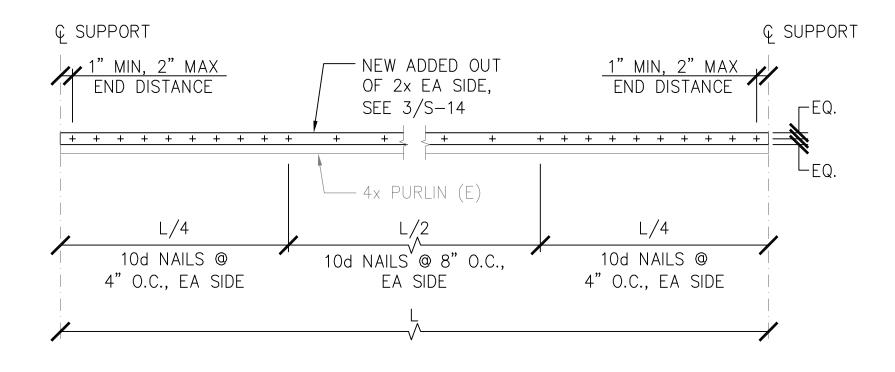

3 DETAIL

S-14 SCALE: 1 1/2" = 1'-0"



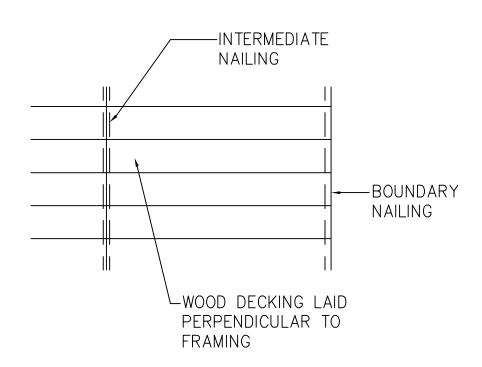

DECKING NAILING		
(PER BOARD, PER END)		
TYPE	BOUNDARIES	INTERMEDIATE
ROOF	3 — 16d	2 — 16d

